

CLINICAL SUPPORT & EDUCATION SIM CENTER TRAINING SPACE RENOVATION, PHASE ||




FOR THE CURATORS OF THE UNIVERSITY OF MISSOURI ISSUED FOR BID 02/21/2025 CP250271

INTERNATIONAL ARCHITECTS ATELIER



I HEREBY CERTIFY THAT DRAWINGS AND/OR SPECIFICATIONS HAVE BEEN PREPARED BY ME, OR UNDER MY SUPERVISION. I FURTHER CERTIFY THAT TO THE BEST OF MY KNOWLEDGE THESE DRAWINGS AND/OR SPECIFICATIONS ARE AS REQUIRED BY AND IN COMPLIANCE WITH BUILDING CODES OF THE UNIVERSITY OF MISSOURI. 2-21-25

MAJID AMIRAHMADI, AIA INTERNATIONAL ARCHITECTS ATELIER

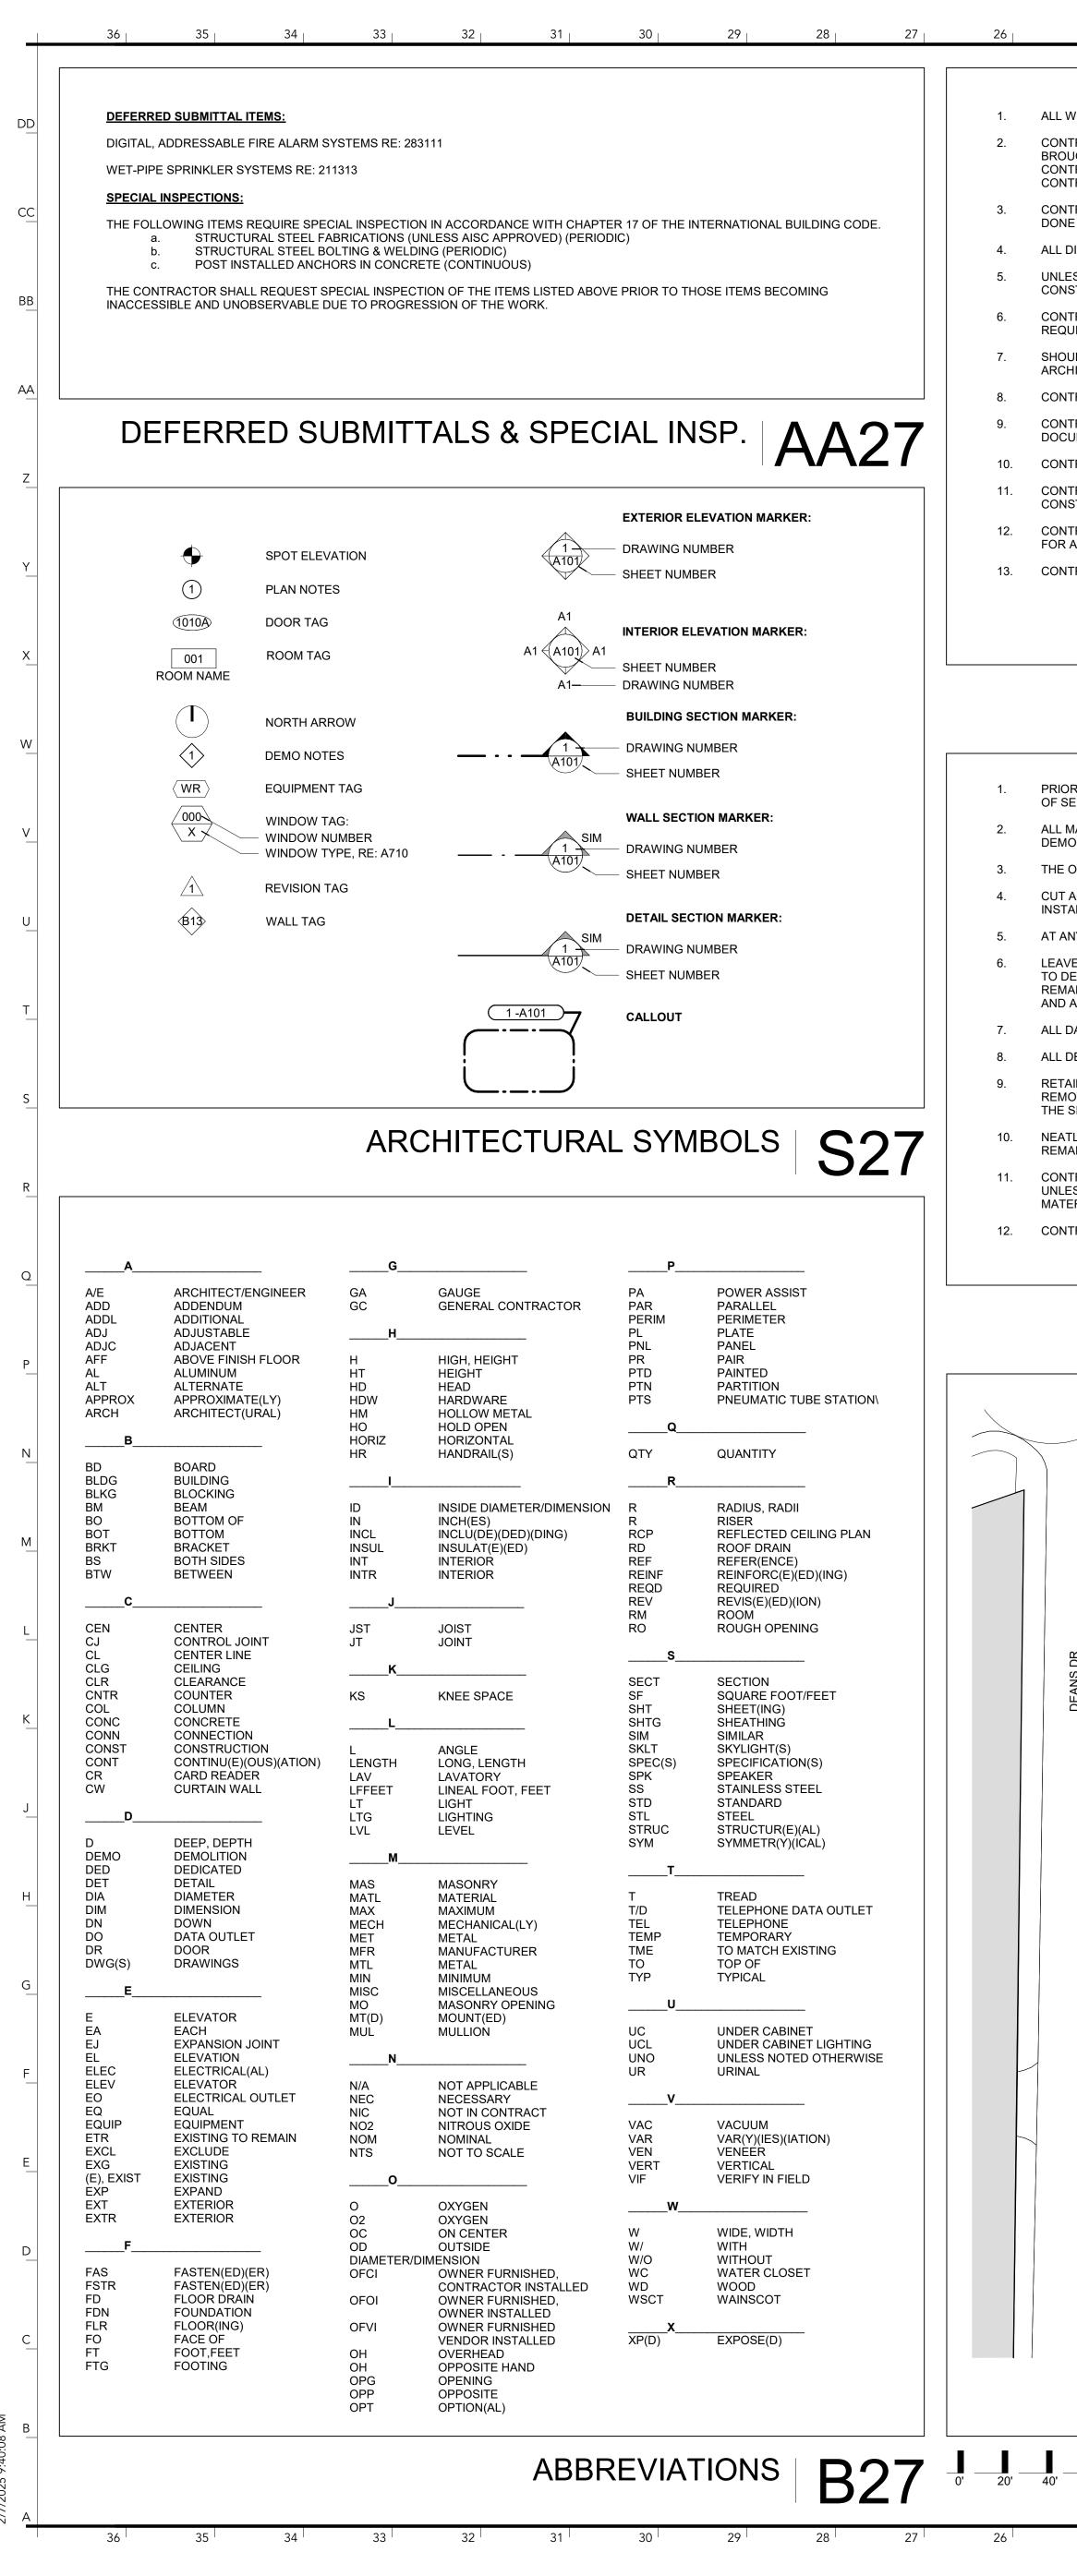

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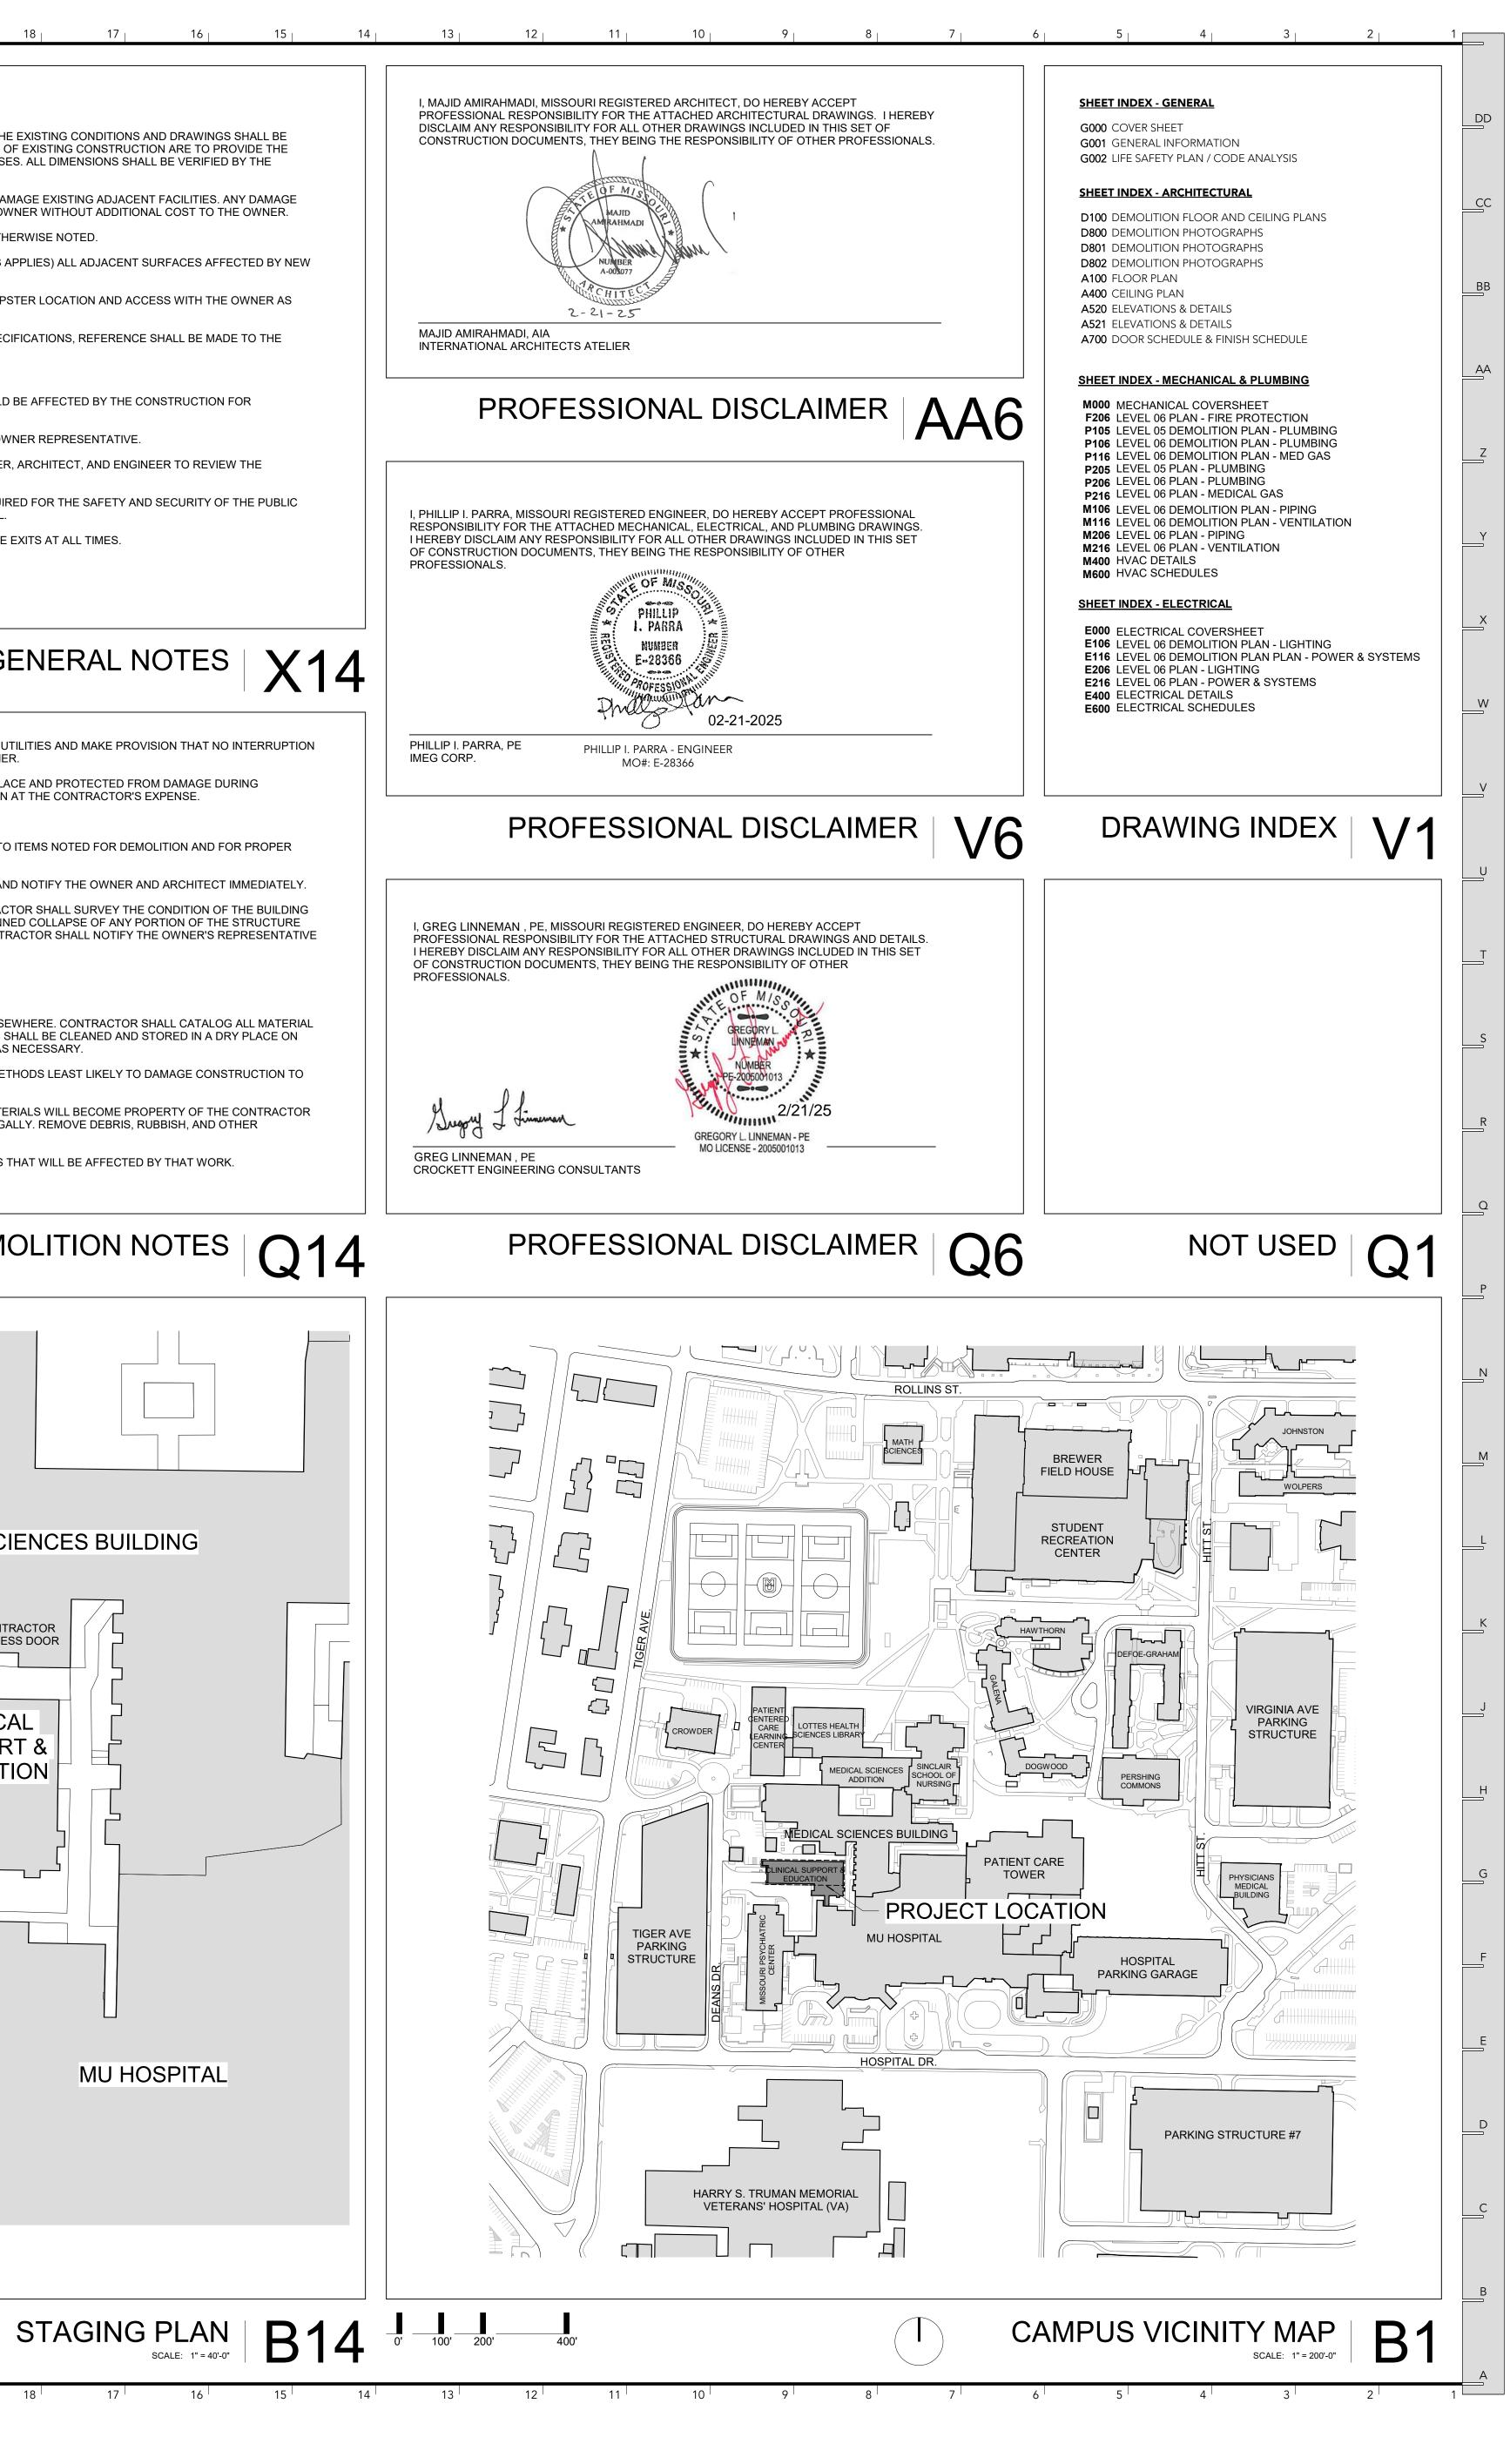
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GENERAL

INFORMATION

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DATE

AMIRAHMADI

APPROVED BY:

SEAL:

DATE: PROJ. NO.:	02/21/2 CP250
	۸.С

DATE: PROJ. NO.:	02/21/2025 CP250271
DESIGNED BY:	AS, BJ
DRAWN BY:	AS, BJ
CHECKED BY:	AS, MA

5 HOSPITAL DR.

COLUMBIA, MO 65201

ISSUED FOR BID

EDUCATION SIM CENTER TRAINING SPACE RENOVATION, PHASE II

FOR THE CURATORS OF THE UNIVERSITY OF MISSOURI

CLINICAL

SUPPORT &




STRUCTURAL CONSULTANT CROCKETT ENGINEERING CONSULTANTS 1000 W. NIFONG BOULEVARD, BUILDING 1 COLUMBIA, MO 65203 PH: 573.447.0292


1600 BALTIMORE, SUITE 300 KANSAS CITY, MO 64108 PH: 816.842.8437

MEP CONSULTANT IMEG CORP.

INTERNATIONAL ARCHITECTS ATELIER 912 BROADWAY BLVD, SUITE 300 | KANSAS CITY, MO 64105 P: 816 471 6522 | F: 816.471.3755 | W: I-A-A.COM MISSOURI STATE CERTIFICATE OF AUTHORITY #000582

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CROCKETT ENGINEERING CONSULTANTS 1000 W. NIFONG BOULEVARD, BUILDING 1 COLUMBIA, MO 65203

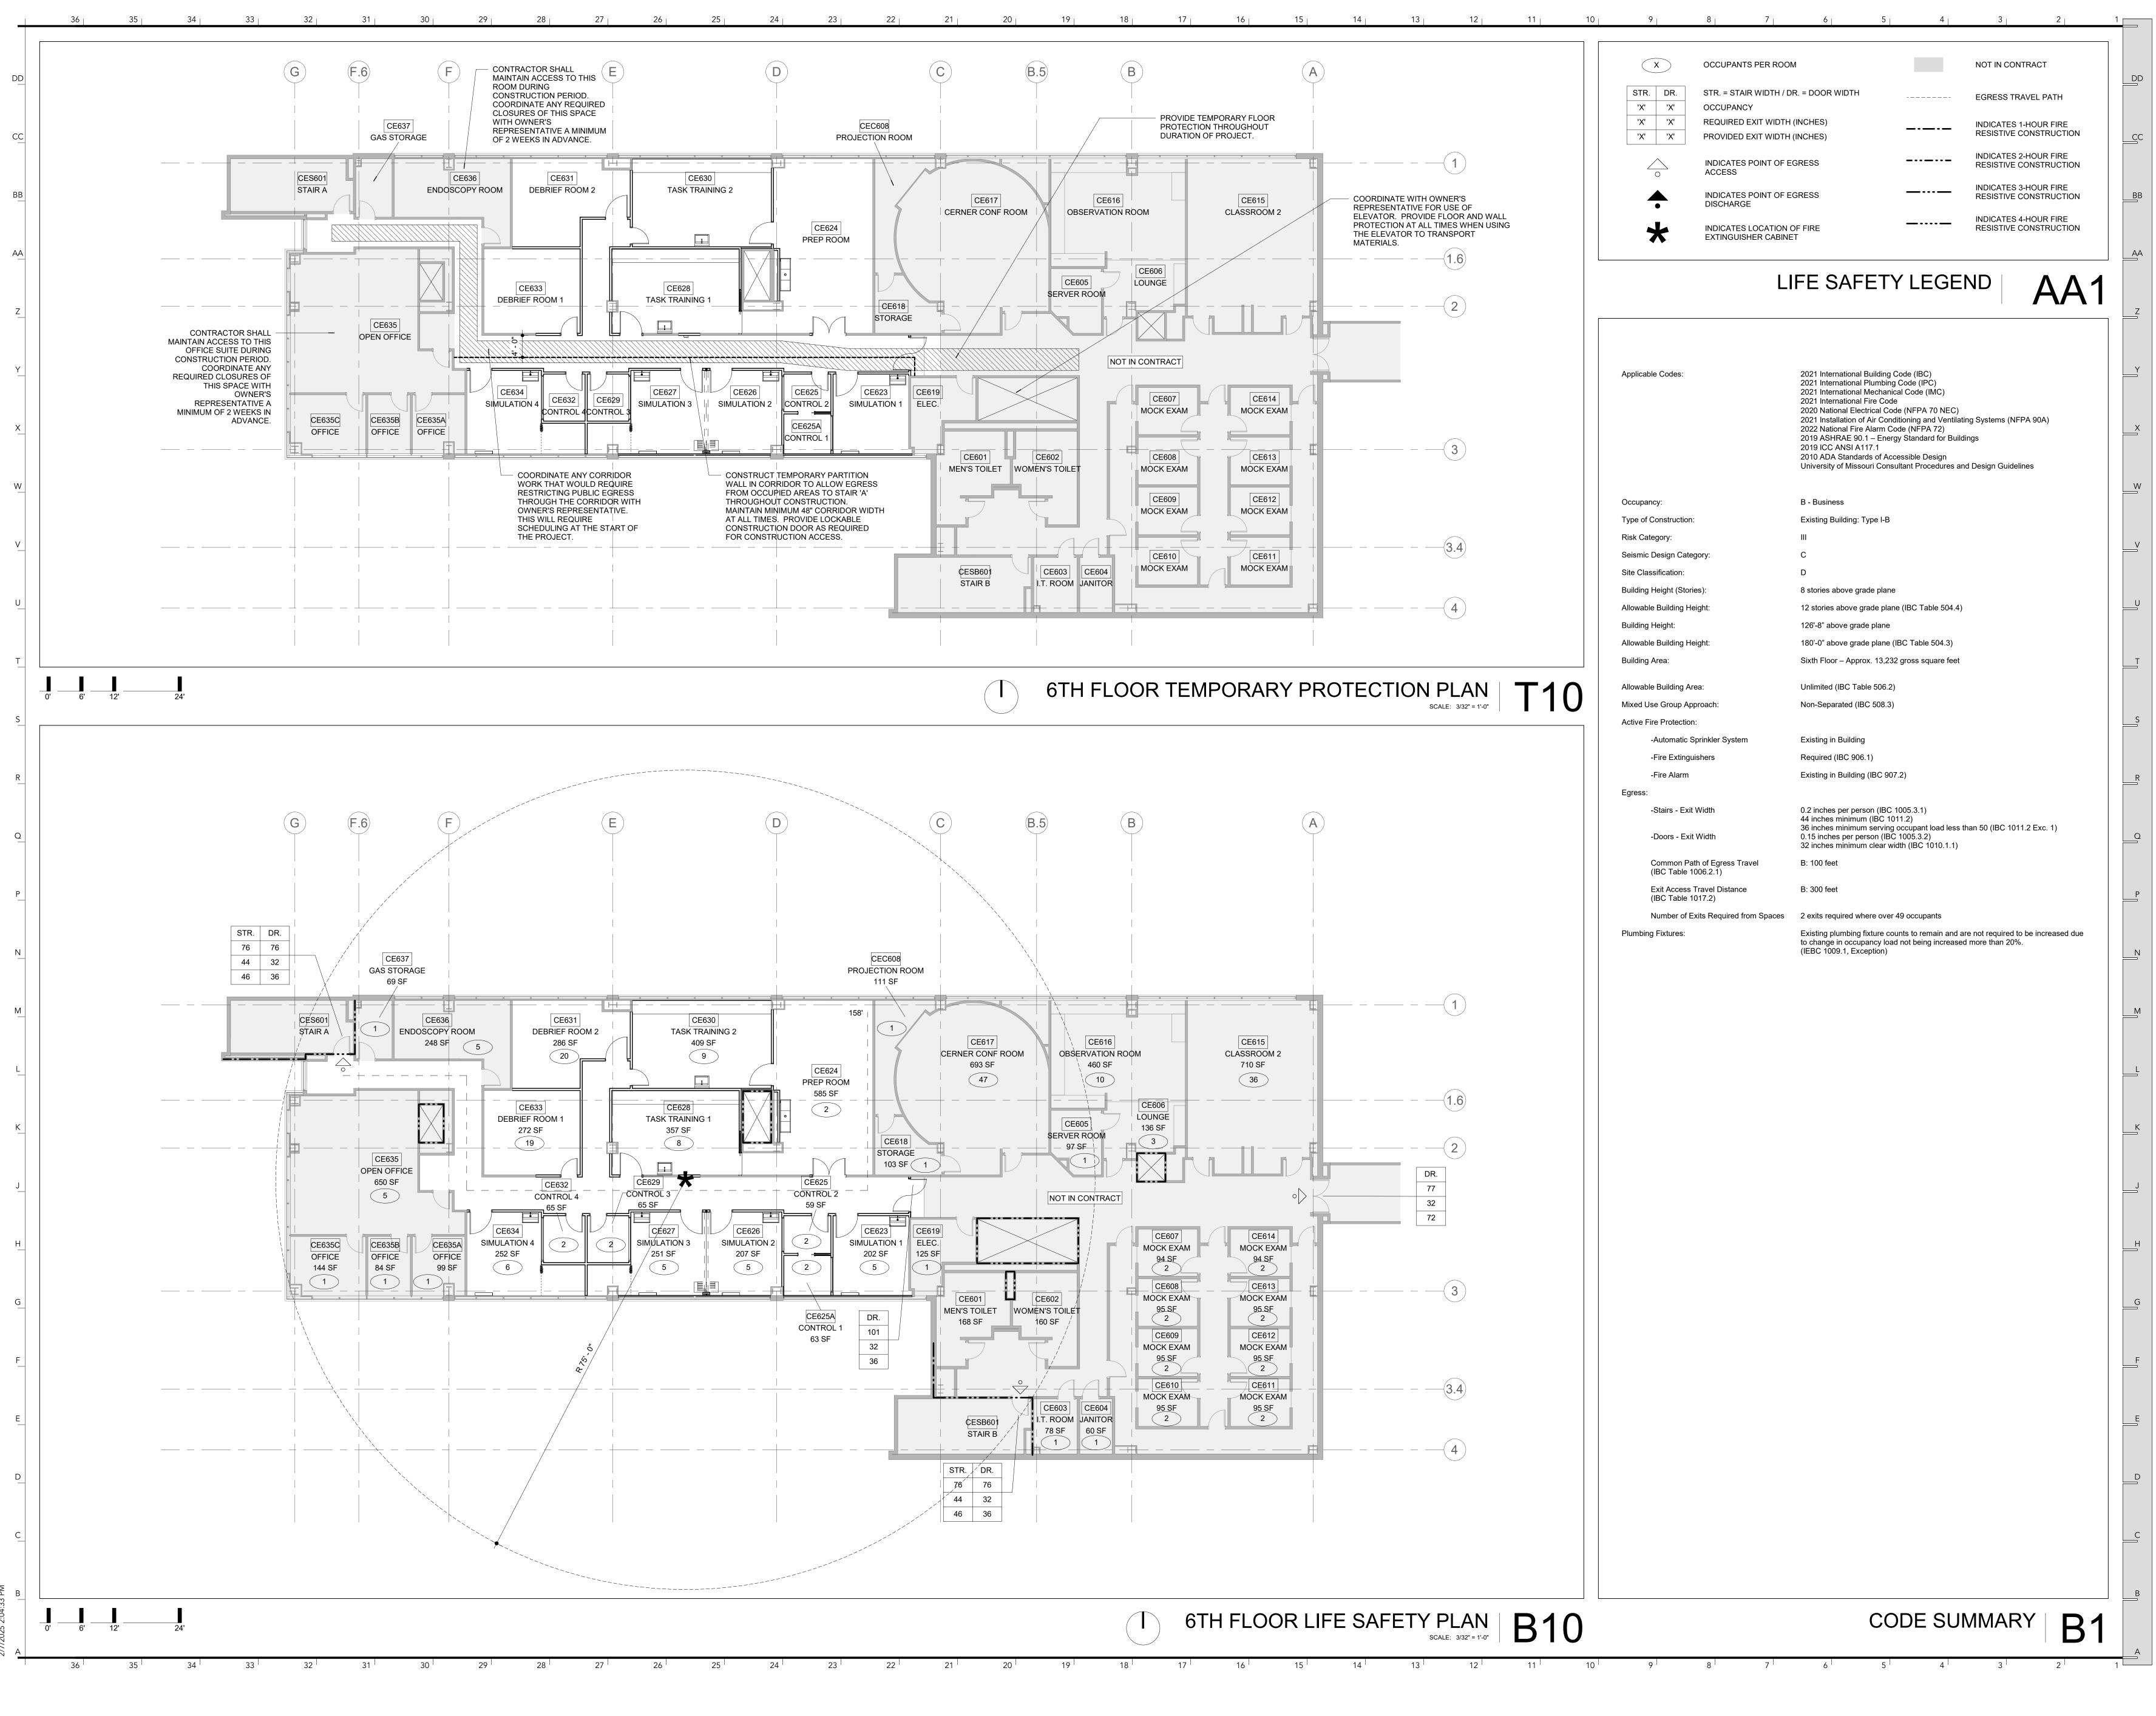PH: 816.842.8437 STRUCTURAL CONSULTANT

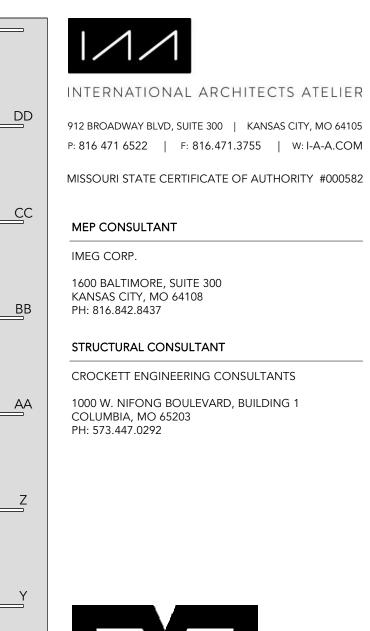KANSAS CITY, MO 64108

1600 BALTIMORE, SUITE 300

PH: 573.447.0292



FOR THE CURATORS OF THE UNIVERSITY OF MISSOURI




ISSUED FOR BID

5 HOSPITAL DR. COLUMBIA, MO 65201

DATE: PROJ. NO.:	02/21/2025 CP250271
DESIGNED BY:	AS, BJ
DRAWN BY:	AS, BJ
CHECKED BY:	AS, MA
APPROVED BY:	MA

SEAL:

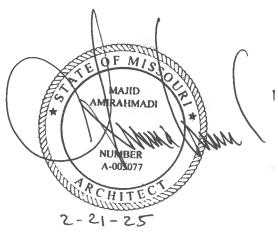

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NO.	REVISION SUBMISSION	DATE
0	ISSUED FOR BID	02/21/2025





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AS, BJ AS, BJ DRAWN BY: CHECKED BY: AS, MA APPROVED BY: SEAL:

02/21/2025 DATE: CP250271 PROJ. NO.: DESIGNED BY:

COLUMBIA, MO 65201

5 HOSPITAL DR.

EDUCATION SIM CENTER TRAINING SPACE RENOVATION, PHASE II **ISSUED FOR BID**

CLINICAL

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THE UNIVERSITY OF MISSOURI

FOR THE CURATORS OF



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2-21-25

SEAL:	
MAJID AMIRAHMADI *	ļ

AS, BJ AS, BJ

AS, MA

MA

DATE: CP250271 PROJ. NO.: DESIGNED BY:

DRAWN BY: CHECKED BY:

APPROVED BY:

ISSUED FOR BID)
5 HOSPITAL DR. COLUMBIA, MO 65201	
DATE:	02/21/2025

EDUCATION -SIM CENTER TRAINING SPACE RENOVATION, PHASE II



FOR THE CURATORS OF THE UNIVERSITY OF MISSOURI

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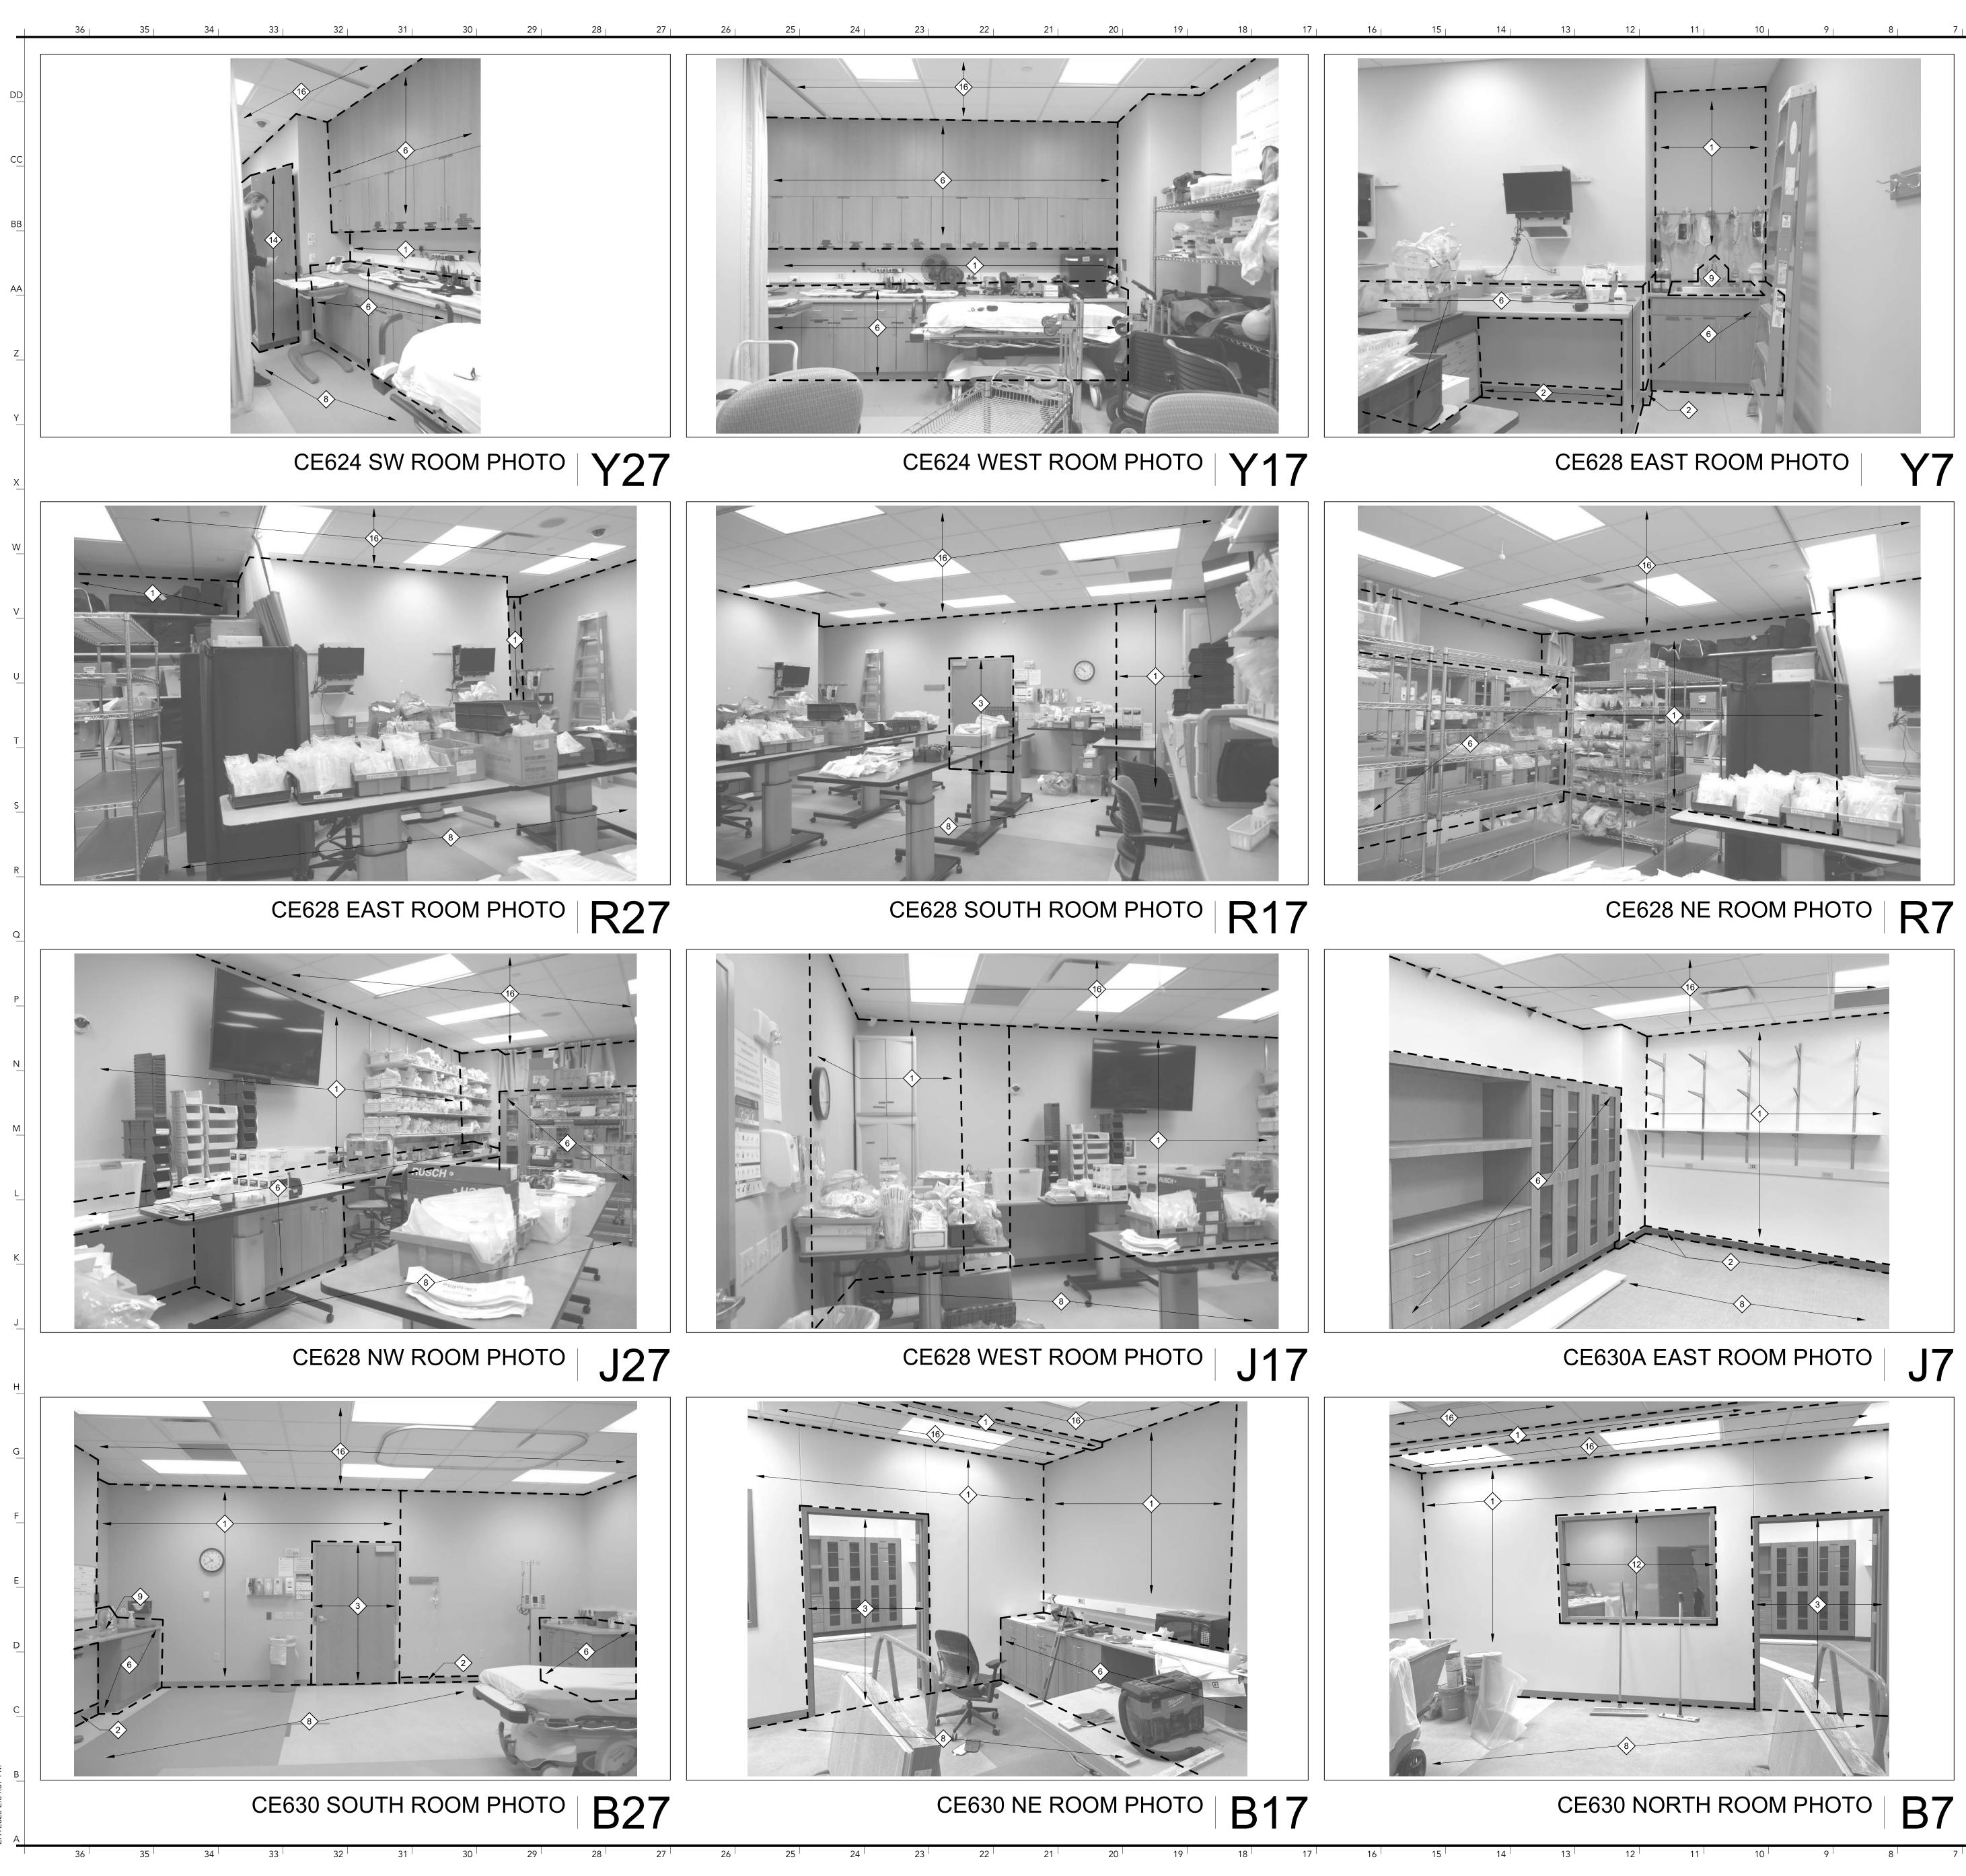
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DEMC	DLITION NOTES:
	INDICATES AREAS OF BUILDING NOT IN CONTRACT
	INDICATES EXISTING ITEMS TO REMAIN.
0F	
1.	REFER TO G001 FOR GENERAL NOTES AND GENERAL DEMOLITION NOTES.
2.	ALL REMOVABLE FURNISHINGS, WALL MOUNTED MEDICAL EQUIPMENT AND CONTAINERS, AND AV EQUIPMENT TO BE REMOVED BY OWNER PRIOR TO START OF CONSTRUCTION.
3.	PREPARE ALL EXISTING WALLS WITHIN PROJECT SCOPE TO RECEIVE NEW PAINT. REMOVE AND PATCH ALL NAIL HOLES AND DAMAGED AREAS IN GYPSUM. REMOVE ALL ADHESIVES AND OTHER MATERIALS THAT WILL AFFECT THE APPLICATION OF NEW PAINT.
4.	SALVAGE ANY ROOM SIGNAGE LOCATED ON WALLS TO BE DEMOLISHED AND TURN OVER TO THE OWNER'S REPRESENTATIVE.
<u>PLAN</u>	<u>NOTES</u>
$\langle 1 \rangle$	REMOVE EXISTING METAL STUD AND GYPSUM BOARD WALL INCLUDING WALL BASE, ALL ASSOCIATED FRAMING, AND ANY ELECTRICAL DEVICES, RECEPTACLES, CONDUIT, ETC. RE: ELECTRICAL DRAWINGS FOR ELECTRICAL DEMOLITION REQUIREMENTS.
$\langle 2 \rangle$	REMOVE EXISTING WALL BASE AND ADHESIVE WITHIN ROOM INDICATED ON PLANS.
3>	REMOVE EXISTING DOOR, DOOR FRAME, HARDWARE, AND ALL ASSOCIATED FRAME ANCHORAGE MATERIALS.
4	REMOVE AND SALVAGE WOOD DOOR FOR REINSTALLATION AT DOOR LOCATION SHOWN ON NEW WORK FLOOR PLAN. REMOVE DOOR FRAME AND HARDWARE AND ALL ASSOCIATED FRAME ANCHORAGE MATERIALS.
$\langle 5 \rangle$	REMOVE DEMOUNTABLE PARTITION WALL AND ALL ASSOCIATED FRAMING.
	REMOVE EXISTING CASEWORK AND COUNTERTOP AND ALL ASSOCIATED HARDWARE.
$\langle \overline{7} \rangle$	REMOVE ALL EXISTING CARPET, WALL BASE, AND ASSOCIATED ADHESIVES DOWN TO STRUCTURAL SLAB. PREPARE FLOOR TO RECEIVE NEW FLOOR FINISH.
8	REMOVE ALL EXISTING VINYL FLOORING, WALL BASE, AND ASSOCIATED ADHESIVES DOWN TO STRUCTURAL SLAB. PREPARE FLOOR TO RECEIVE NEW FLOOR FINISH.
9	REMOVE AND SALVAGE PLUMBING FIXTURE AND DELIVER TO OWNER'S REPRESENTATIVE. REFER TO PLUMBING DRAWINGS FOR ADDITIONAL INFORMATION.
(10)	REMOVE EXISTING WINDOW BLINDS, INCLUDING ALL BRACKETS AND ACCESSORIES.
	REMOVE EXISTING SOLID SURFACE WINDOW SILL.
$\langle 12 \rangle$ $\langle 13 \rangle$	REMOVE HOLLOW METAL FRAME AND ONE-WAY GLASS. REMOVE AND SALVAGE ALL HEADWALL CONTROLS AND
~	DELIVER TO OWNER'S REPRESENTATIVE. REFER TO PLUMBING DRAWINGS FOR ADDITIONAL INFORMATION.
<14 ~	REMOVE HEADWALL MILLWORK UNIT.
<15>	REMOVE WALLCOVERING AND SKIM COAT WALL TO RECEIVE NEW PAINTED FINISH.
(16)	REMOVE EXISTING ACOUSTICAL CEILING TILE, GRID AND ASSOCIATED HARDWARE AND SUSPENSION SYSTEM. REMOVE EXISTING LIGHT FIXTURES AND DIFFUSERS AND GRILLES. REFER TO MECHANICAL AND ELECTRICAL DRAWINGS FOR ADDITIONAL INFORMATION.
17>	REMOVE EXISTING GYPSUM BOARD CEILING. REMOVE EXISTING LIGHT FIXTURES. REFER TO ELECTRICAL DRAWINGS FOR ADDITIONAL INFORMATION.
18	REMOVE AND SALVAGE FIRE EXTINGUISHER AND CABINET FOR REINSTALLATION AT LOCATION SHOWN ON NEW WORK FLOOR PLAN.

REMOVE EXISTING WALL PROTECTION AND PATCH WALLS TO REMAIN.

DEMO NOTES

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2-21-2 be considered prepared by this architect, and this architect expressly disclaims any and all responsibility for such plans drawings, or documents not exhibiting this seal. NO. REVISION SUBMISSION DATE 0 ISSUED FOR BID DEMOLITION PHOTOGRAPHS D801

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5 HOSPITAL DR. COLUMBIA, MO 65201	
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DESIGNED BY:	AS, BJ

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DEMO NOTES **B1**

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STRUCTURAL CONSULTANT

AA 1000 W. NIFONG BOULEVARD, BUILDING 1 COLUMBIA, MO 65203 PH: 573.447.0292

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FOR THE CURATORS OF THE UNIVERSITY OF MISSOURI




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DRAWN BY:	AS, BJ
CHECKED BY:	AS, MA
APPROVED BY:	MA


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CLINICAL

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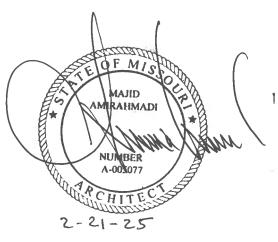
EDUCATION SIM CENTER TRAINING SPACE RENOVATION, PHASE II

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FLOOR PLAN

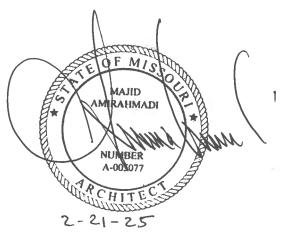

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MEP CONSULTANT

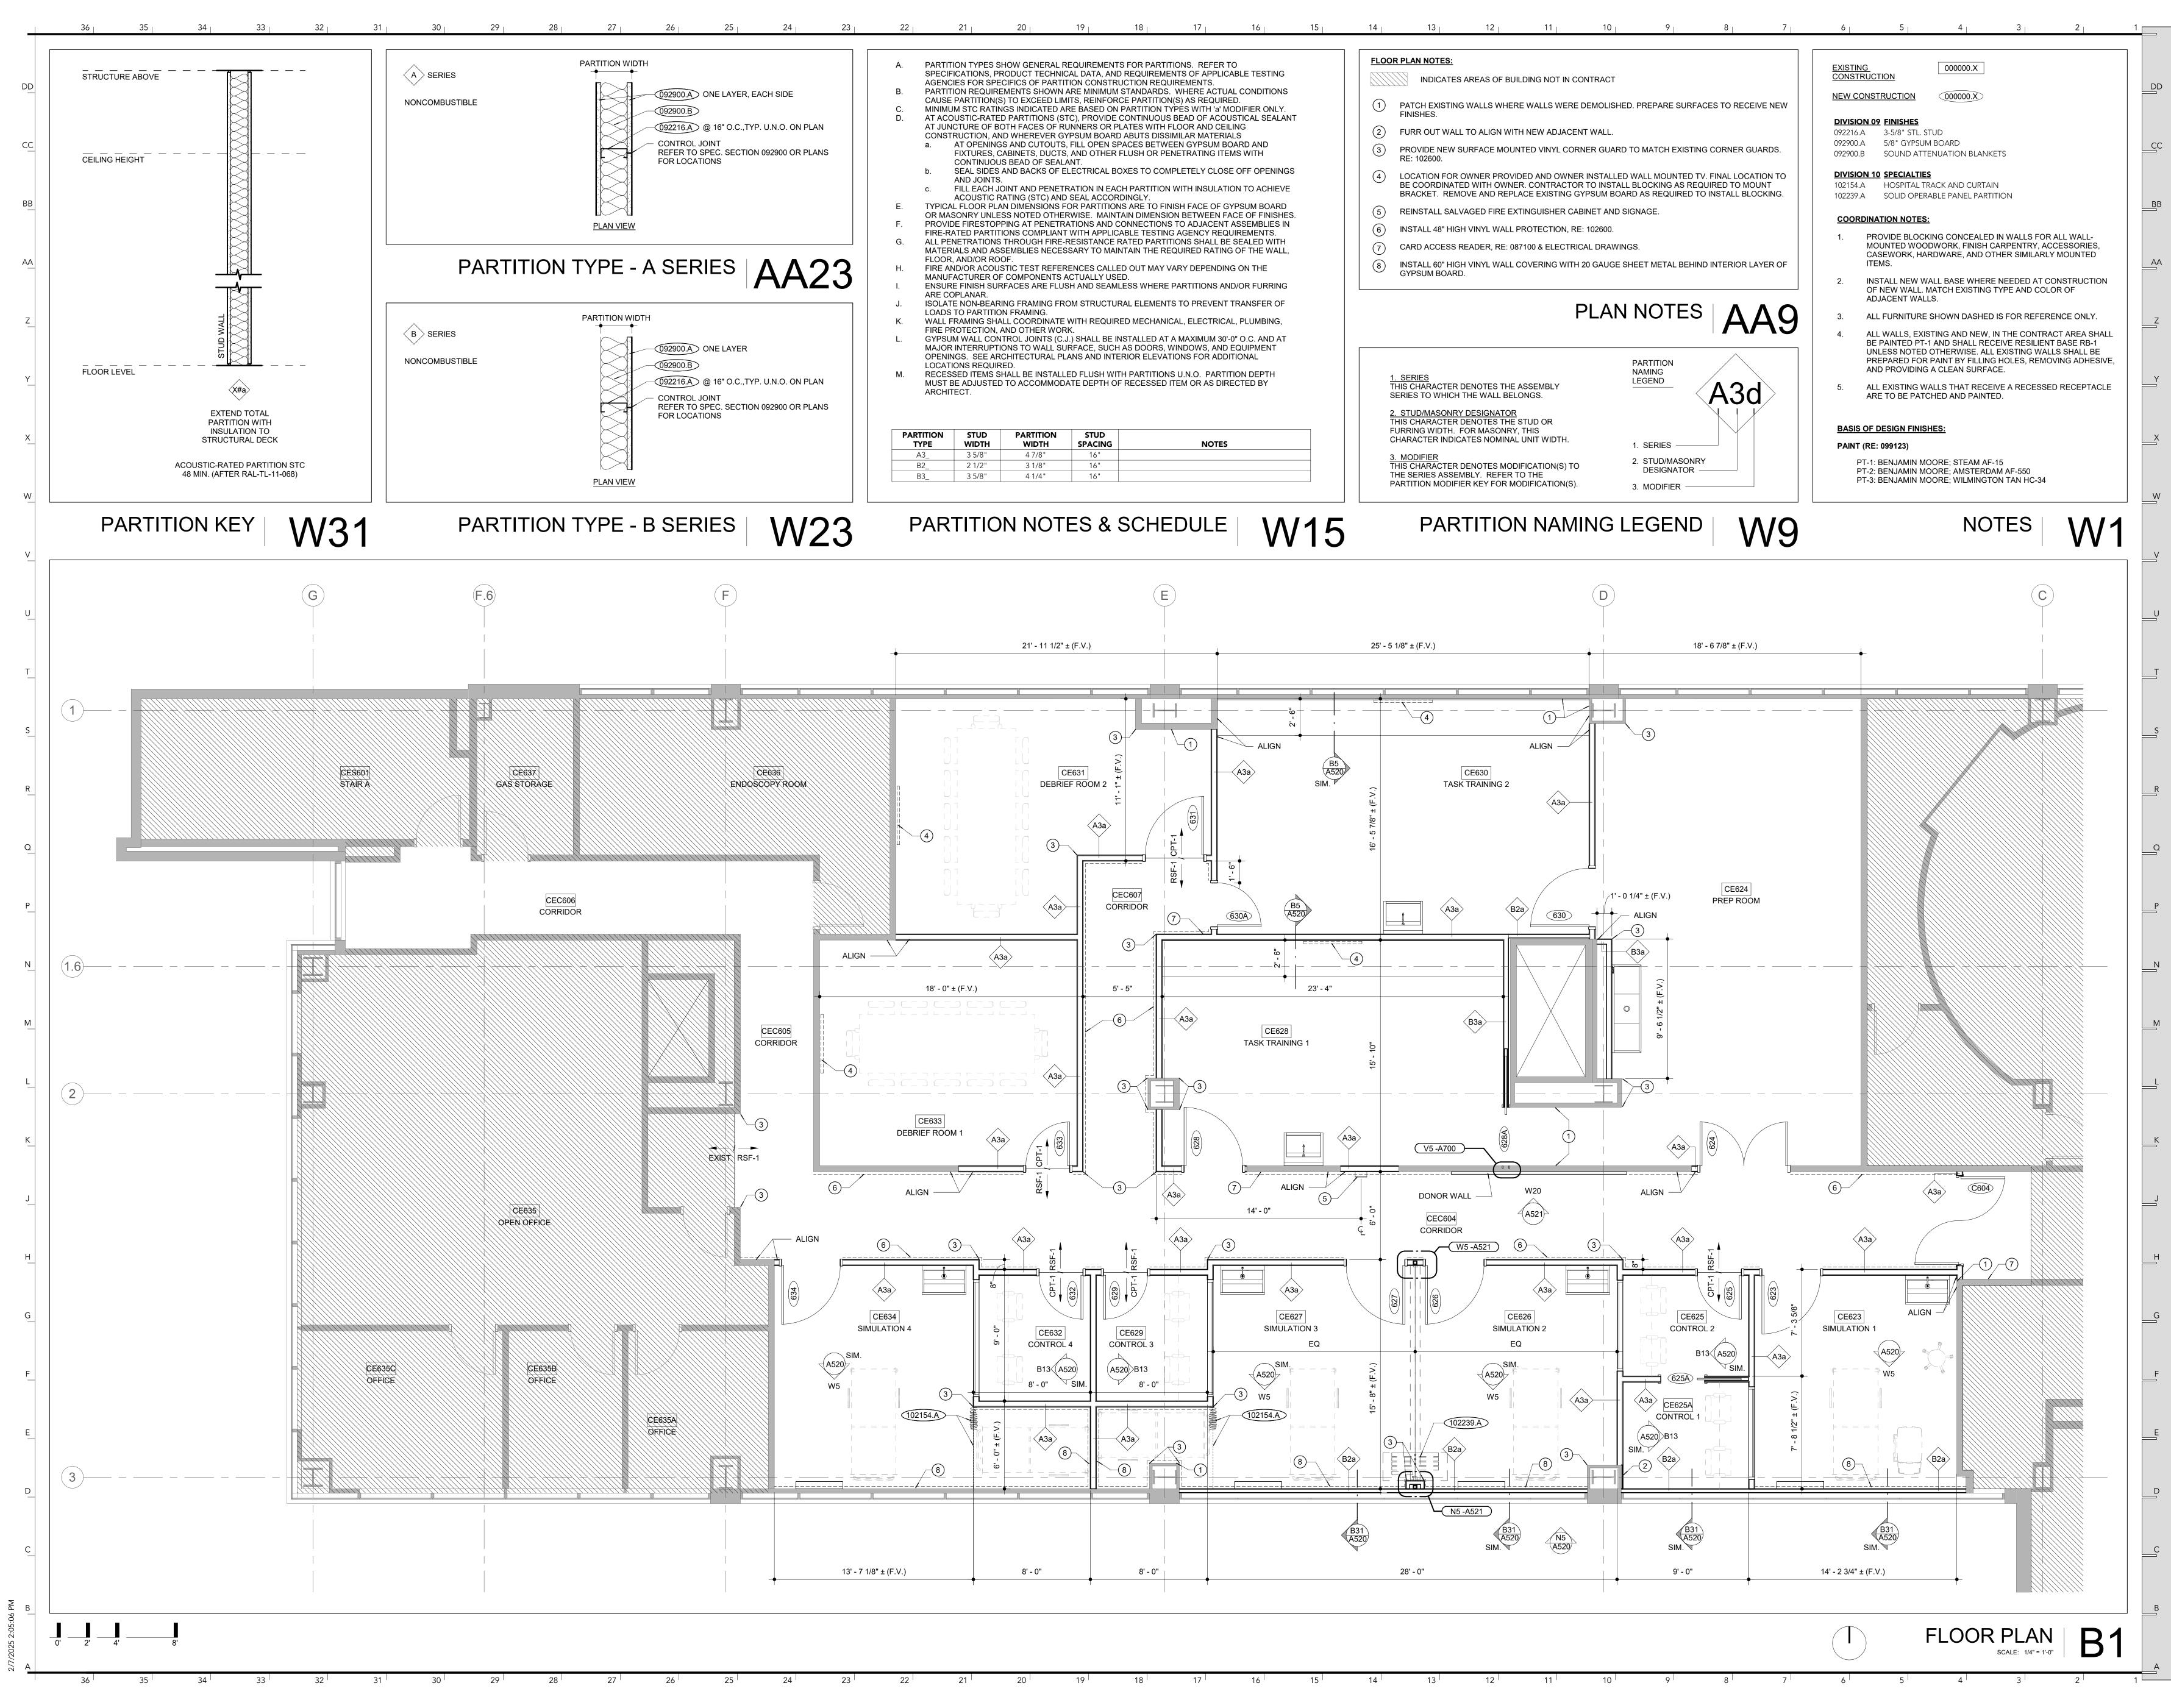1600 BALTIMORE, SUITE 300

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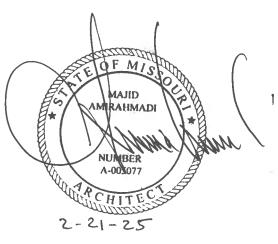
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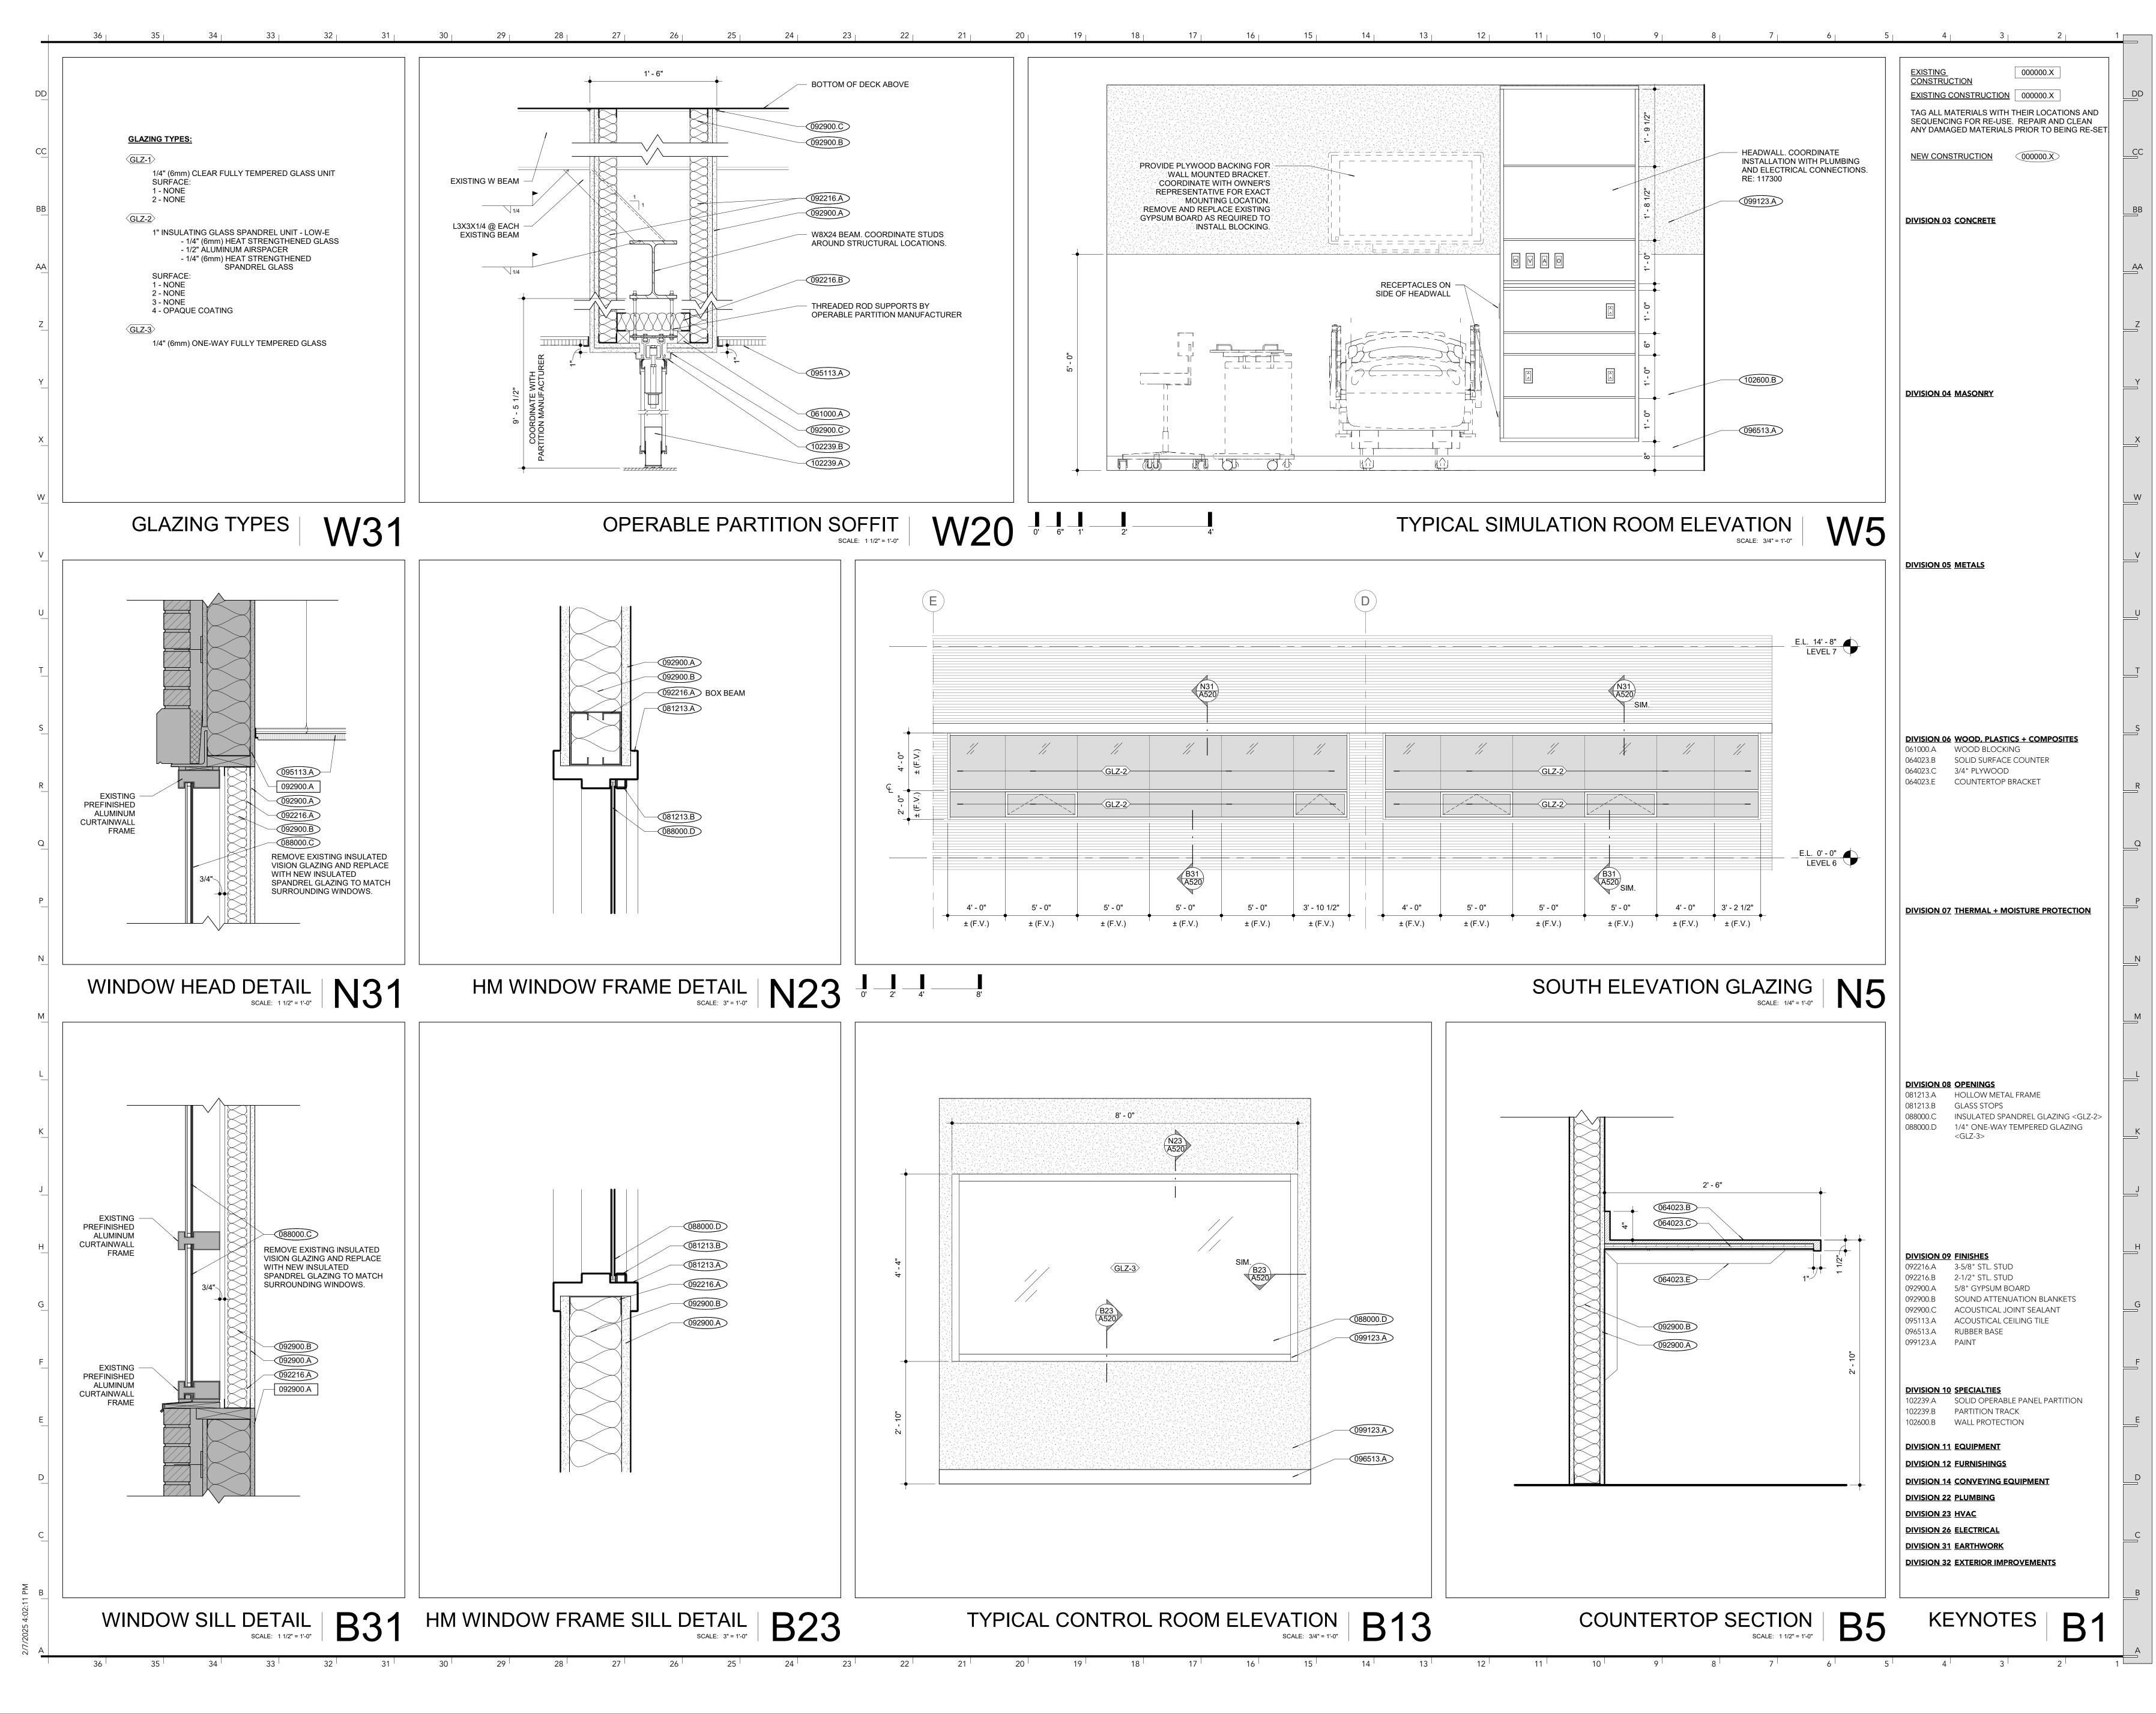


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CEILING PLAN







FOR THE CURATORS OF THE UNIVERSITY OF MISSOURI

CLINICAL

SUPPORT &

EDUCATION

SIM CENTER

RENOVATION,

TRAINING

SPACE

PHASE II

5 HOSPITAL DR.

DATE:

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PROJ. NO.:

DESIGNED BY:

APPROVED BY:

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02/21/2025

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DATE

02/21/202


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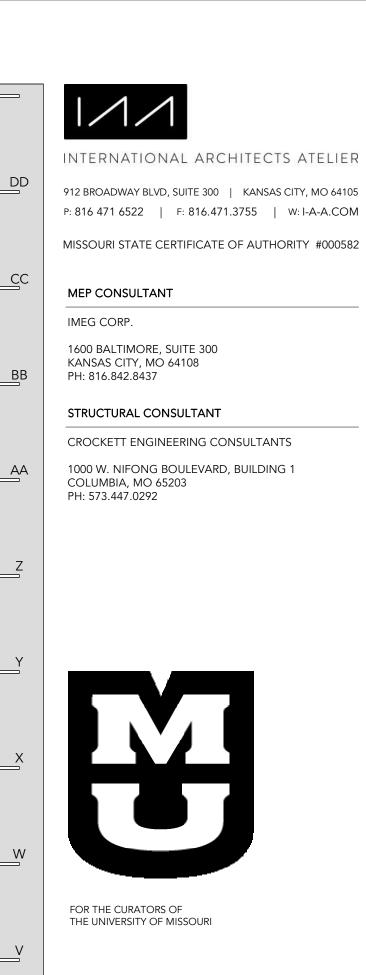
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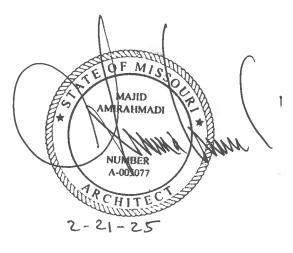


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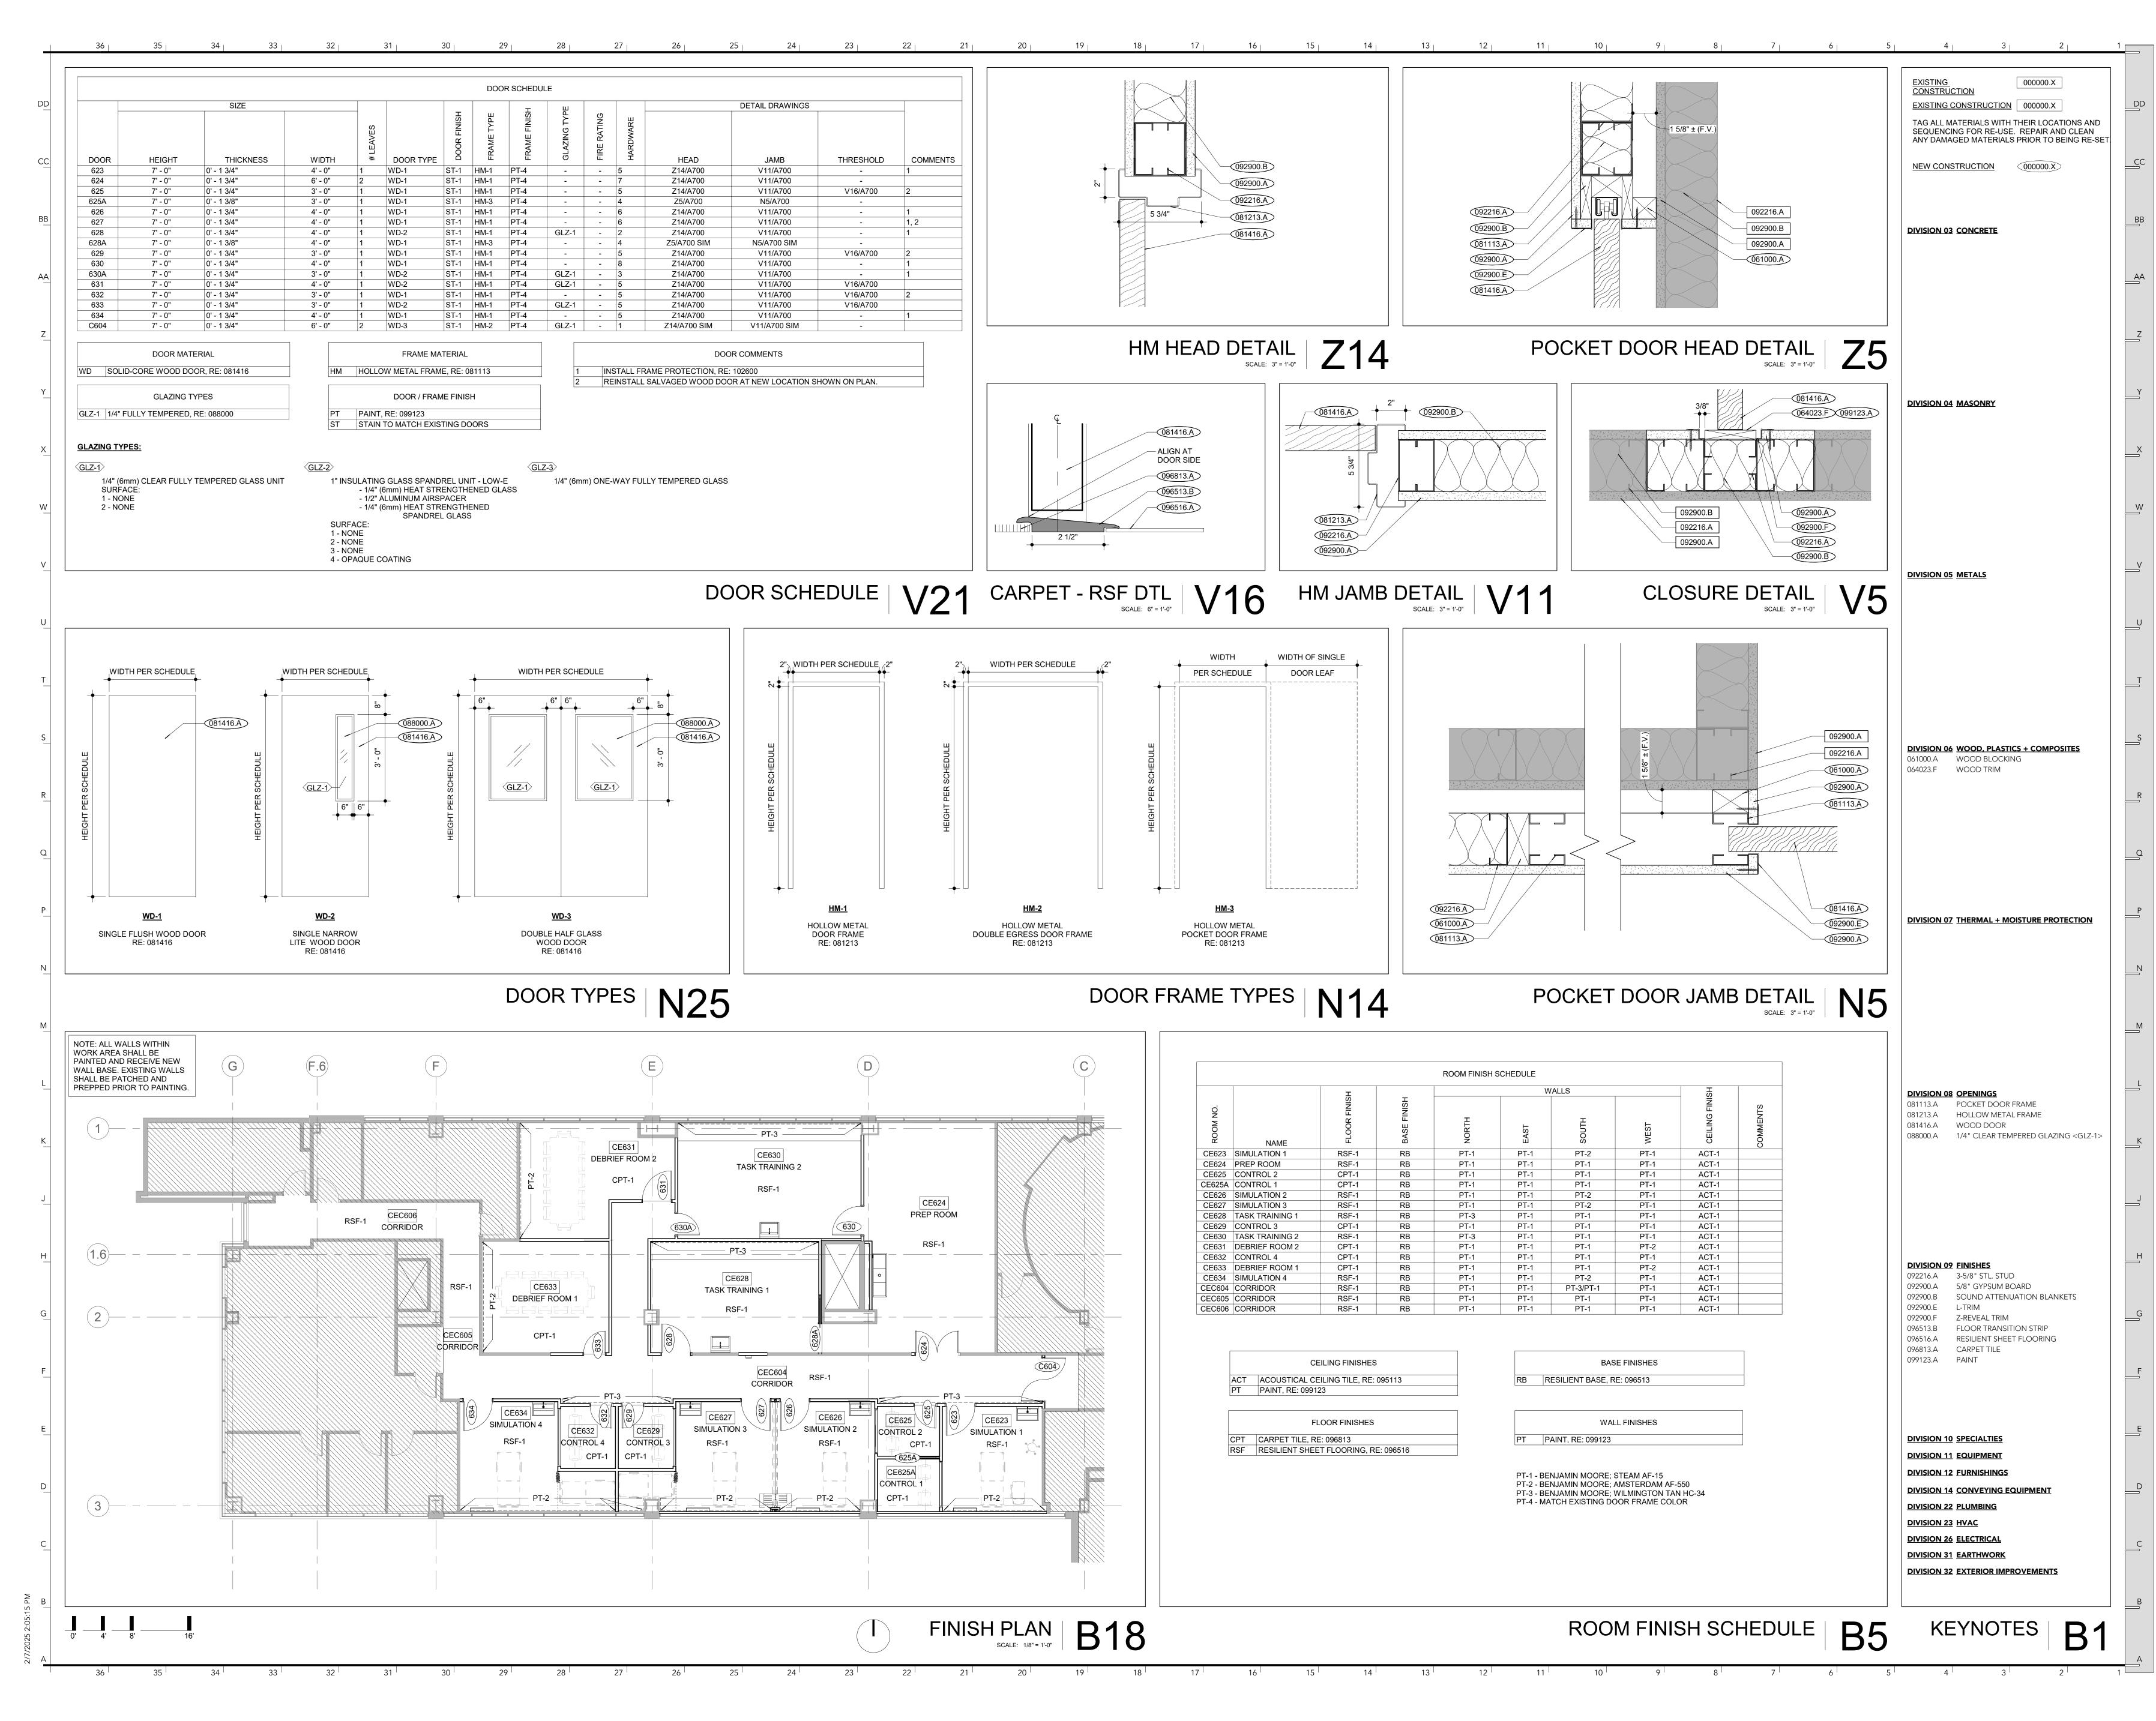


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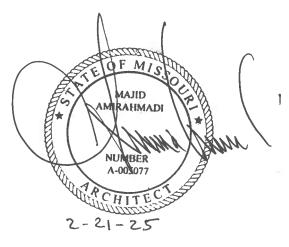


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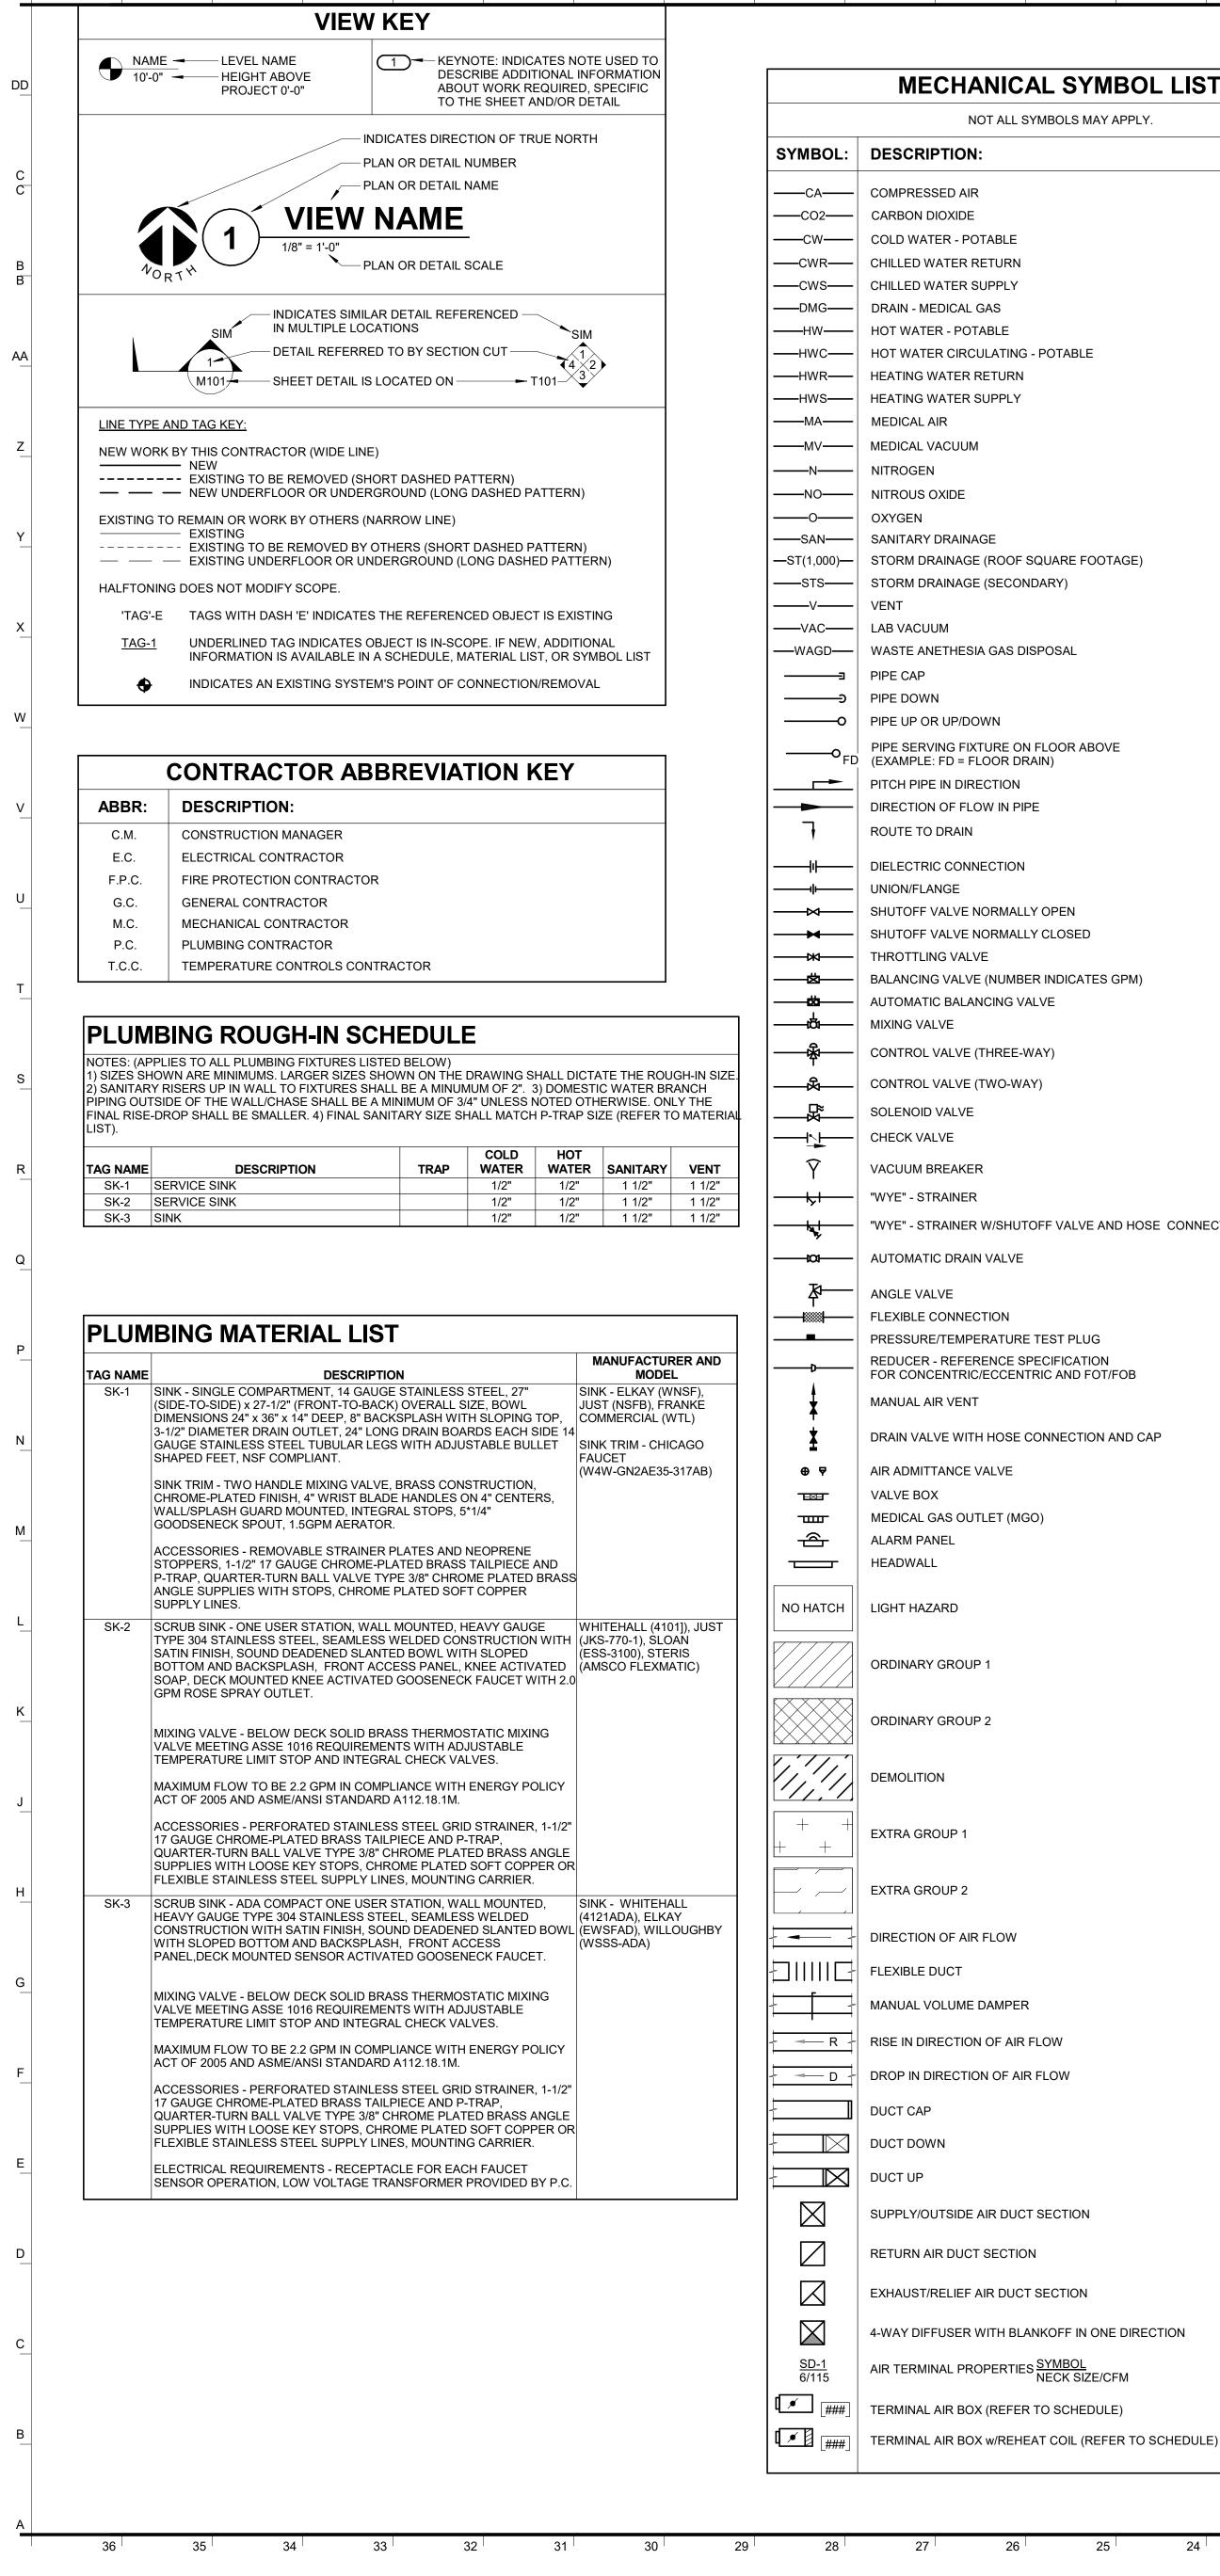


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TOFF VALVE AND HOSE CONNECTION WITH CAP				11. CAU	LK ALL PIPE ANI	D DUCT PEN			NON-FIRE RATED	
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ABBK:	DESCRIPTION:
AD	ACCESS DOOR
AFF	ABOVE FINISHED FLOOR
со	CLEANOUT
DN	DOWN
Е	EXISTING
EWC	ELECTRIC WATER COOLER
FCO	FLOOR CLEANOUT
FD	FIRE DAMPER
FMCS	FACILITY MANAGEMENT AND CONTROL SYSTEM
FSD	FIRE/SMOKE DAMPER
L or LAV	LAVATORY
MB	MOP BASIN
MV	MIXING VALVE
N.C.	NORMALLY CLOSED
NIC	NOT IN CONTRACT
N.O.	NORMALLY OPEN
SCCR	SHORT CIRCUIT CURRENT RATING
SD	SMOKE DAMPER
SK	SINK
SS	SERVICE SINK
TAB	TERMINAL AIR BOX
TD	TRANSFER DUCT
TYP	TYPICAL
UON	UNLESS OTHERWISE NOTED
WC	WATER CLOSET
WCO	WALL CLEANOUT

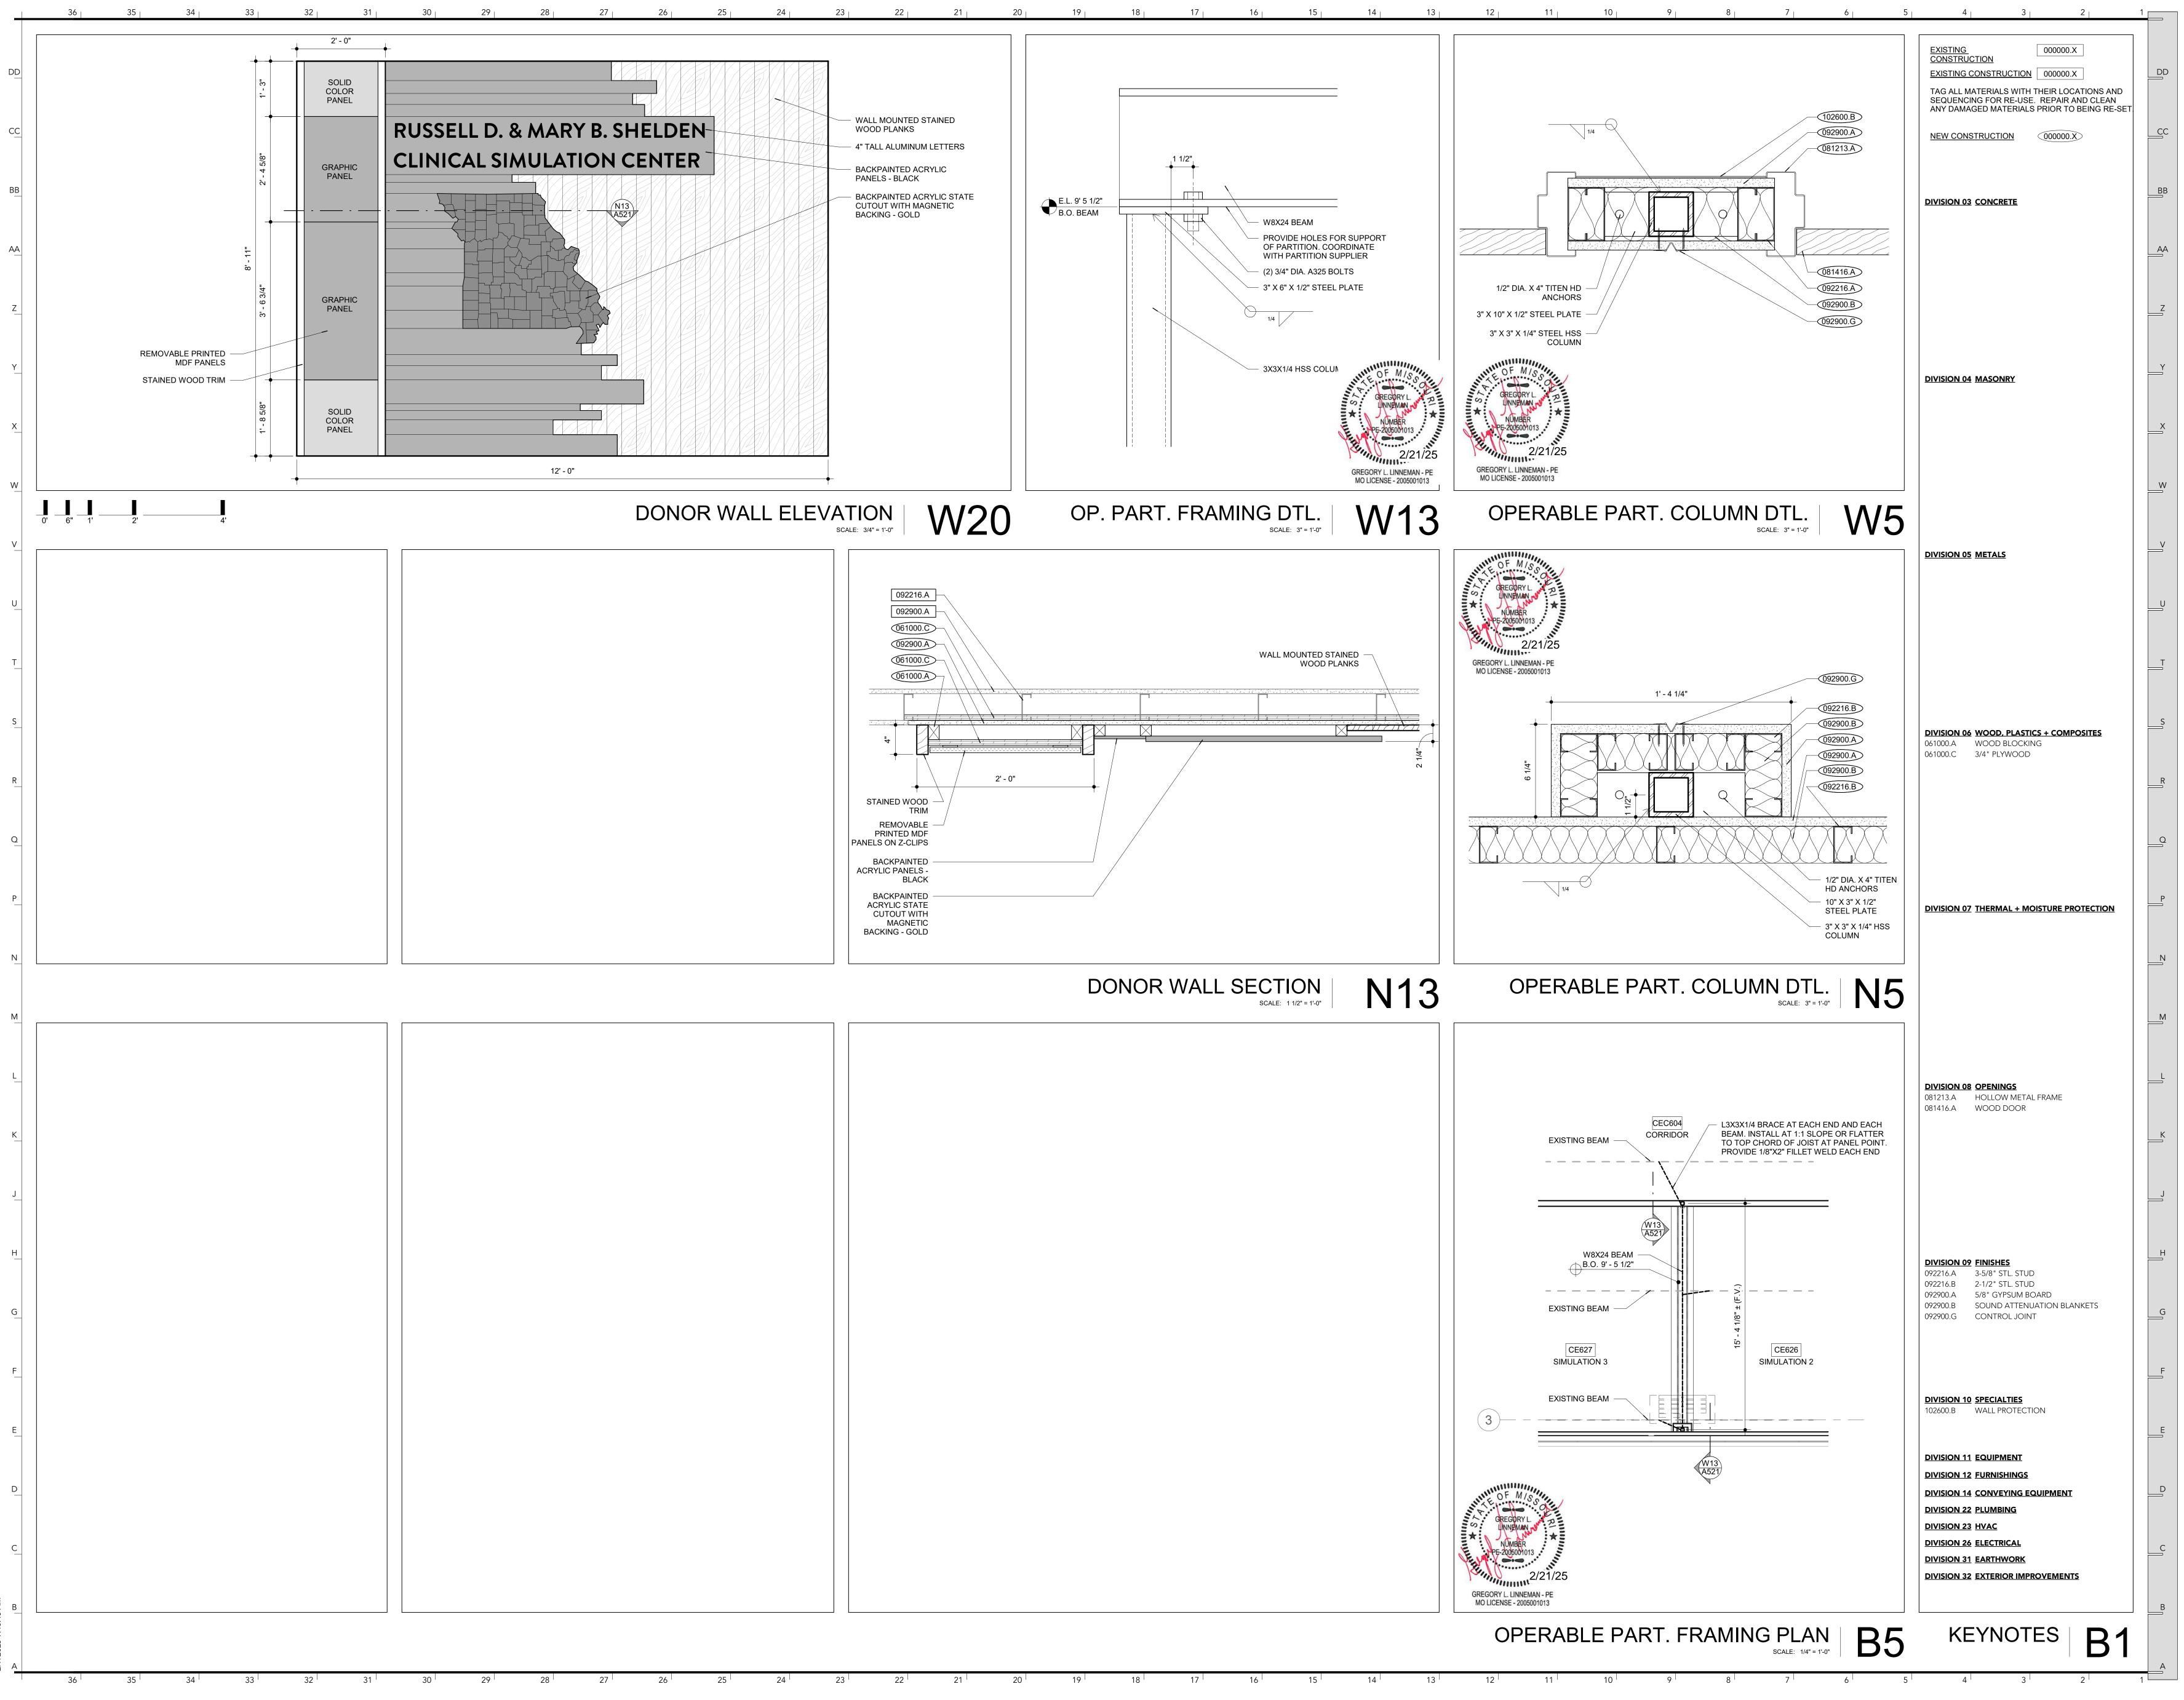DUCT ABBREVIATION KEY

ABBR. DESCRIPTION RA SA

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RETURN/RELIEF AIR

SUPPLY AIR

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DESIGN.

EACH OTHER.

CHANICAL RENOVATION NOTES:

DITIONS ARE SHOWN BASED ON INFORMATION OBTAINED FROM FIELD TING BUILDING DOCUMENTS, AND STAFF. VERIFY EXISTING CONDITIONS AND ONFLICTS BEFORE PROCEEDING. ING DUCTWORK AND PIPING IS SHOWN. VERIFY EXISTING CONDITIONS

FING WORK. NOTIFY ENGINEER OF ANY CONFLICTS WITH NEW WORK. THE AVAILABLE CLEARANCES FOR DUCTWORK AND PIPING BEFORE RISES AND DROPS MAY BE NECESSARY BECAUSE OF EXISTING FIELD

CTOR SHALL FIELD VERIFY ACCESSIBILITY TO THE AREA OF THEIR WORK AND THE GENERAL CONTRACTOR PRIOR TO BIDDING IF OTHER UTILITIES ARE BE REMOVED OR RELOCATED TO ALLOW ACCESS TO THEIR AREA OF WORK. CONTRACTOR IS RESPONSIBLE FOR CUTTING, REMOVAL AND PATCHING OF , AND FLOORS ASSOCIATED WITH WORK BY ALL CONTRACTORS. S SHALL NOTIFY THE GC OF AFFECTED AREAS PRIOR TO BIDDING CONTRACTOR IS RESPONSIBLE FOR REMOVAL AND REPLACEMENT OF ING TILES, AND CEILING GRIDS ASSOCIATED WITH AREAS OF WORK BY ALL

. NOTIFY THE GENERAL CONTRACTOR OF AFFECTED AREAS PRIOR TO NG MECHANICAL SYSTEMS ARE LOCATED IN AREAS THAT CONFLICT WITH IT, PIPING, OR DUCTWORK TO BE INSTALLED, EACH CONTRACTOR SHALL GE NEW EQUIPMENT, PIPING, OR DUCTWORK IN SUCH A FASHION THAT IT FLICT WITH EXISTING SYSTEMS, OR REWORK EXISTING MECHANICAL LLOW FOR INSTALLATION OF NEW EQUIPMENT, PIPING, OR DUCTWORK PORARY CONNECTIONS TO MAINTAIN EXISTING SYSTEMS IN SERVICE DURING

SSION FROM OWNER BEFORE SHUTTING DOWN ANY SYSTEM FOR ANY TAIN SERVICE TO ALL COMPONENTS THAT ARE TO REMAIN UNTIL NEW

INSTALLED TING SYSTEM IN SERVICE UNTIL NEW SYSTEM IS COMPLETE AND READY FOR TCHOVER. DRAIN SYSTEM ONLY TO MAKE SWITCHOVERS AND . OBTAIN PERMISSION FROM OWNER BEFORE PARTIALLY OR COMPLETELY EM. MAKE CHANGEOVER TO NEW SYSTEMS WITH MINIMUM OUTAGE. ND REMOVE MECHANICAL DEVICES AND EQUIPMENT SERVING EQUIPMENT REMOVED.

MECHANICAL GENERAL NOTES:

PLY TO ALL MECHANICAL SHEETS AND TRADES, INCLUDING BUT NOT LIMITED TION, PLUMBING, MEDICAL GAS, VENTILATION, PIPING AND TEMPERATURE

IOWING LOCATIONS OF EQUIPMENT, DUCTWORK, PIPING, ETC. ARE C AND MAY NOT ALWAYS REFLECT EXACT INSTALLATION CONDITIONS. HOW THE GENERAL ARRANGEMENT OF DUCTWORK, PIPING, EQUIPMENT, ETC., INCLUDE ALL OFFSETS AND FITTINGS REQUIRED FOR COMPLETE . THE DRAWINGS SHALL BE FOLLOWED AS CLOSELY AS ACTUAL BUILDING ON AND THE WORK OF OTHERS WILL PERMIT. E DRAWINGS. VERIFY ALL DIMENSIONS AND CLEARANCES FROM

AL, STRUCTURAL, SUBMITTALS, AND OTHER APPROPRIATE DRAWINGS OR T SITE. REVIEW ALL DRAWINGS, INCLUDING THOSE OF OTHER TRADES. ALL WORK WITH ALL OTHER TRADES PRIOR TO INSTALLATION TO PROVIDE REQUIRED FOR OPERATION, MAINTENANCE, CODE COMPLIANCE, AND TO NTERFERENCE WITH OTHER WORK. DO NOT FABRICATE PRIOR TO I OF NECESSARY CLEARANCES FOR ALL TRADES. BRING ANY INTERFERENCES S TO THE ATTENTION OF THE ARCHITECT/ENGINEER BEFORE PROCEEDING ATION OR EQUIPMENT ORDERS.

CE REQUIREMENTS OF EQUIPMENT SPECIFIED OR SUBSTITUTED AND MAKE ACCOMMODATIONS IN LAYOUT AND POSITIONING TO PROVIDE PROPER S REQUIRED TO ELIMINATE CONFLICTS OR THAT RESULT FROM A FAILURE TO

VICES. OTHER THAN SPRINKLERS. ACTOR IS RESPONSIBLE FOR DAMAGE CAUSED BY THEIR ACTIONS TO WALLS. INGS, AND ROOFS. THE CONTRACTOR WHOSE WORK CAUSES DAMAGE IS FOR PATCHING TO MATCH ORIGINAL CONSTRUCTION, FIRE RATING, AND

H DRYWALL CEILINGS COORDINATE LOCATIONS OF ACCESS PANELS WITH THE ESS TO VALVES, DUCTWORK ACCESSORIES, DAMPERS, ETC. COORDINATE ND COLOR WITH ARCHITECT. NOTIFY THE GC OF THE REQUIRED ACCESS R TO BIDDING OR AND WALL PENETRATIONS AIRTIGHT WHERE CONDUITS, PIPING, AND

PE AND DUCT PENETRATIONS OF FULL HEIGHT NON-FIRE RATED WALL. _OOR, AND ROOF ASSEMBLIES, THIS IS ESSENTIAL TO PREVENT NOISE N FROM ONE ROOM TO ANOTHER AND TO PROVIDE THE DESIRED NC LEVELS

S AND DUCTS ARE SHOWN TO PENETRATE FLOORS, PROVIDE SLEEVED TH THE TOP EDGE RAISED ABOVE FLOOR SURFACE IN ACCORDANCE WITH ALL EC SECTIONS. SEAL SLEEVE PERIMETER TO BE WATERTIGHT. SIZES AND SERVICE CLEARANCE REQUIREMENTS VARY AMONG DIFFERENT RERS. CONSULT APPROVED SHOP DRAWINGS FOR EQUIPMENT SIZES AND RVICE CLEARANCES. COORDINATE WITH LAYOUT OF EQUIPMENT PADS,

WORK, ETC. K TUBE PULL OR EQUIPMENT SERVICE CLEARANCES. IINIMUM WORKING CLEARANCE OF 3'-6" IN FRONT OF ALL ELECTRICAL REQUIRING MAINTENANCE, INSPECTION, AND TESTING INCLUDING BUT NOT ANELS, DISTRIBUTION PANELS, SWITCHBOARDS, MOTOR CONTROL CENTERS, ERS, EQUIPMENT DISCONNECTS AND STARTERS. E DEDICATED ELECTRICAL EQUIPMENT SPACE DEFINED BY THE WIDTH / DEPTH AL EQUIPMENT MEASURED FROM THE FLOOR TO A HEIGHT 6'-0" ABOVE THE EQUIPMENT OR THE STRUCTURAL CEILING, WHICHEVER IS LOWER. SYSTEMS FOREIGN TO THE ELECTRICAL DISTRIBUTION SYSTEM ARE NOT ALLOWED IN THE DEDICATED

ELECTRICAL SPACE INCLUDING: DUCTWORK, PIPING, ETC. 7. PROVIDE CONCRETE EQUIPMENT PAD FOR ALL FLOOR MOUNTED EQUIPMENT. PAD SHALL EXTEND MINIMUM 6" BEYOND ALL SIDES OF EQUIPMENT. 18. DO NOT SUPPORT EQUIPMENT, PIPING, OR DUCTWORK FROM METAL DECKING OR OTHER NON-STRUCTURAL BUILDING ELEMENTS. ANCHORS EMBEDDED IN CONCRETE SHALL BE CRACKED CONCRETE APPROVED IN ACCORDANCE WITH SPECIFICATIONS.

VENTILATION GENERAL NOTES:

UNLESS NOTED OTHERWISE, THE SIZE OF EACH BRANCH DUCT TO A TERMINAL AIR BOX (TAB) SHALL MATCH THE INLET SIZE UNLESS THE BRANCH IS GREATER THAN 6 FEET IN LENGTH, IN WHICH CASE THE BRANCH DUCT SHALL BE SIZED AT A PRESSURE DROP OF 0.07" W.C. PER 100' OF DUCTWORK. . UNLESS NOTED OTHERWISE, THE SIZE OF EACH BRANCH DUCT TO AN AIR TERMINAL SHALL MATCH THE INLET SIZE. . ALIGN TEMPERATURE SENSORS WITH LIGHT SWITCHES AND WHEN IN CLOSE PROXIMITY TO

PROVIDE ACCESS DOORS AT ALL DUCT MOUNTED EQUIPMENT 5. EXISTING AIR INLET AND OUTLET CFM SHOWN ON DRAWINGS ARE FROM EXISTING DRAWINGS, AND ARE FOR REFERENCE ONLY. CONTRACTOR SHALL USE PRE-BALANCE VALUES, AND NOT EXISTING CFM SHOWN ON DRAWINGS . CONTRACTOR MAY REUSE PORTIONS OF EXISTING DUCT PROVIDED SIZES AND PRESSURE

CLASSES ARE CORRECT, DUCT IS THOROUGHLY CLEANED AND FREE OF DEFECTS, AND ALL TRANSVERSE JOINTS, LONGITUDINAL SEAMS, AND DUCT WALL PENETRATIONS ARE SEALED AS SPECIFIED FOR NEW DUCTWORK.

PIPING GENERAL NOTES:

1. THE SIZE OF BRANCH PIPING TO TERMINAL HEATING DEVICES AND COILS SHALL BE 3/4" UNLESS NOTED OTHERWISE. 2. PIPE DRAIN LINES FROM EQUIPMENT TO NEAREST FLOOR DRAIN. 3. INSTALL ALL REFRIGERANT LIQUID AND SUCTION PIPING SIZED PER EQUIPMENT MANUFACTURER RECOMMENDATIONS.

MEDICAL GAS GENERAL NOTES:

THE SYMBOLS AND THE MATERIAL LIST ARE FOR THE CONVENIENCE OF THE CONTRACTOR CONTRACTOR SHALL VERIFY QUANTITIES AND FURNISH ALL MATERIALS REQUIRED FOR FULLY OPERATIONAL SYSTEMS, WHETHER SPECIFIED OR NOT. CATALOG NUMBERS SHALL NOT BE CONSIDERED COMPLETE, BUT ARE GIVEN AS AN AID TO THE CONTRACTOR AND TO INDICATE THE QUALITY REQUIRED. CONTRACTOR IS RESPONSIBLE FOR A COMPLETE DESCRIPTION OF MATERIAL ON THESE DRAWINGS AND IN THE SPECIFICATIONS BEFORE ORDERING. THE DESCRIPTION OF THE MATERIAL TAKES PRECEDENCE OVER THE CATALOG NUMBER. THE FIRST MANUFACTURER IS THE BASIS OF

3. INSTALL WALL MOUNTED OUTLETS 60" AFF UNLESS NOTED OTHERWISE. COORDINATE ELEVATIONS WITH ARCHITECTURAL DRAWINGS. 4. REFER TO MEDICAL GAS MATERIAL LIST FOR PIPE SIZES TO INDIVIDUAL OUTLETS. 5. MEDICAL GAS SYSTEM IS TO BE CERTIFIED UNDER THE CONTRACTOR'S SCOPE OF WORK.

FIRE PROTECTION GENERAL NOTES:

1. THE SYMBOLS AND THE MATERIAL LIST ARE FOR THE CONVENIENCE OF THE CONTRACTOR. CONTRACTOR SHALL VERIFY QUANTITIES AND FURNISH ALL MATERIALS REQUIRED FOR FULLY OPERATIONAL SYSTEMS, WHETHER SPECIFIED OR NOT. 2. CATALOG NUMBERS SHALL NOT BE CONSIDERED COMPLETE, BUT ARE GIVEN AS AN AID TO THE CONTRACTOR AND TO INDICATE THE QUALITY REQUIRED. CONTRACTOR IS RESPONSIBLE FOR COMPLETE DESCRIPTION OF MATERIAL ON THESE DRAWINGS AND IN THE SPECIFICATIONS BEFORE ORDERING. THE DESCRIPTION OF THE MATERIAL TAKES PRECEDENCE OVER THE CATALOG NUMBER. THE FIRST MANUFACTURER IS THE

- BASIS OF DESIGN 3. CENTER SPRINKLERS IN CEILING TILES IN BOTH DIRECTIONS IN ALL AREAS. IN AREAS WITH 2'X4' CEILING TILES CENTERING USING A 2'X2' CEILING PATTERN IS ACCEPTABLE. SPRINKLER HEADS SHALL BE ALIGNED WITH OTHER SPRINKLER HEADS, LIGHTING, DIFFUSERS, AND ANY OTHER FEATURES IN THE CEILING. 4. NEW SPRINKLERS SHALL BE QUICK RESPONSE TYPE, UNLESS OTHERWISE NOTED.
- CONTRACTOR SHALL NOT MIX STANDARD RESPONSE SPRINKLERS WITH QUICK RESPONSE SPRINKLERS IN UNPARTITIONED SPACES. PROVIDE COVERAGE ABOVE AND BELOW ALL DUCTWORK GREATER THAN 48" WIDE. 6. PROVIDE COVERAGE ABOVE (IF APPLICABLE) AND BELOW FLOATING CEILINGS, REFER
- TO ARCHITECTURAL PLANS 7. FIRE PROTECTION PIPE ROUTING IS SHOWN FOR GENERAL LAYOUT. DETERMINE EXACT
- NUMBER OF SPRINKLERS, PIPE SIZING, AND PIPE ROUTING. 8. THE FIRE PROTECTION SYSTEM SHALL BE DESIGNED TO MEET OWNER'S INSURANCE COMPANY STANDARDS WHERE APPLICABLE. THE MORE STRINGENT OF THE OWNER'S INSURANCE UNDERWRITER'S DESIGN CRITERIA AND THE NFPA STANDARDS SHALL BE
- 9. ALL BUILDING AREA SHALL BE FULLY SPRINKLERED INCLUDING CANOPIES, WALKWAYS, OVERHANGS, SOFFITS, AND BUILDING PROJECTIONS. ALL ACCESSIBLE COMBUSTIBLE CONCEALED SPACES SHALL BE FULLY PROTECTED BY THE SPRINKLER SYSTEM. 10. EACH ASSEMBLY SHALL INCLUDE BUTTERFLY CONTROL VALVE INDICATING "OPEN" OR
- "CLOSED" POSITION. TEST INSPECTION VALVE, FLOW SWITCH AND PRESSURE GAUGES. 11. WHERE FEASIBLE INSTALL PIPES HIGH AS POSSIBLE TO AVOID CONFLICT WITH OTHER DISCIPLINES
- 12. INSTALL SYSTEM DRAINS AT LOW POCKET AREAS CONTAINING FIVE GALLONS OF WATER OR MORE, PROVIDE WITH ISOLATION VALVE AND THREADED HOSE CONNECTION
- 13. MAIN PIPING PASSING BELOW SKYLIGHTS OR CLERESTORIES ARE NOT PERMITTED. 14. FOLLOW STRUCTURAL DETAILS WHEN PENETRATING OR PASSING THROUGH STRUCTURAL ELEMENTS. ALTERNATE DESIGNS WILL NEED TO BE APPROVED THROUGH THE STRUCTURAL ENGINEER.
- 15. PROVIDE INTERMEDIATE TEMPERATURE SPRINKLER HEADS WHERE REQUIRED BY NFPA 13 UNLESS OTHERWISE NOTED 16. FINAL HEAD LOCATION, TYPE AND FINISH SHALL BE REVIEWED AND APPROVED BY THE
- ARCHITECT. 17. PAINT ALL EXPOSED PIPING TO MATCH BACKGROUND OR AS DIRECTED BY THE
- ARCHITECT 18. THE OWNER MUST BE NOTIFIED PRIOR TO EACH AND EVERY DRAINING OR RECHARGING OF THE SPRINKLER SYSTEM
- 19. THE CONTRACTOR SHALL PREPARE A COORDINATED SET OF SHOP DRAWINGS AND SHALL OBTAIN APPROVAL FROM THE AUTHORITIES HAVING JURISDICTION AND THE LOCAL FIRE DEPARTMENT PRIOR TO ANY INSTALLATION. 20. DRAWING SHOW LOCATIONS OF EQUIPMENT, DUCTWORK, PIPING, ETC. ARE
- DIAGRAMMATIC AND MAY NOT ALWAYS REFLECT EXACT INSTALLATION CONDITIONS. DRAWINGS SHOW THE GENERAL ARRANGEMENT OF DUCTWORK, PIPING, EQUIPMENT, ETC. AND MAY NOT INCLUDE ALL OFFSETS AND FITTINGS REQUIRED FOR COMPLETE INSTALLATION. THE DRAWINGS SHALL BE FOLLOWED AS CLOSELY AS ACTUAL BUILDING
- CONSTRUCTION AND THE WORK OF OTHERS WILL PERMIT. 21. VERIFY ALL DIMENSIONS AND CLEARANCES FROM ARCHITECTURAL, STRUCTURAL, SUBMITTALS, AND OTHER APPROPRIATE DRAWINGS OR PHYSICALLY AT SITE. REVIEW
- ALL DRAWINGS. INCLUDING THOSE OF OTHER TRADES. 22. ALL SPRINKLER HEADS TO BE INSTALLED ARE REQUIRED BE BRAND NEW. RELOCATION OF EXISTING HEADS IS PROHIBITED.
- 23. CONTRACTOR TO COORDINATE SPRINKLER SYSTEM SHUT DOWN WITH OWNER'S REPRESENTATIVE. MINIMIZE NUMBER OF SHUT DOWNS AND OUTAGE DURATION FOR OCCUPIED AREAS. OUTAGES TO OCCUPIED AREAS ARE LIMITED TO NORMAL WORKING HOURS.

PLUMBING GENERAL NOTES:

- 1. THE SYMBOLS AND THE MATERIAL LIST ARE FOR THE CONVENIENCE OF THE CONTRACTOR. CONTRACTOR SHALL VERIFY QUANTITIES AND FURNISH ALL MATERIALS REQUIRED FOR FULLY OPERATIONAL SYSTEMS, WHETHER SPECIFIED OR NOT. 2. CATALOG NUMBERS SHALL NOT BE CONSIDERED COMPLETE. BUT ARE GIVEN AS AN AID TO
- THE CONTRACTOR AND TO INDICATE THE QUALITY REQUIRED. CONTRACTOR IS RESPONSIBLE FOR A COMPLETE DESCRIPTION OF MATERIAL ON THESE DRAWINGS AND IN THE SPECIFICATIONS BEFORE ORDERING. THE DESCRIPTION OF THE MATERIAL TAKES PRECEDENCE OVER THE CATALOG NUMBER. THE FIRST MANUFACTURER LISTED IS THE
- BASIS OF DESIGN. 3. CONTRACTOR SHALL VERIFY THAT FIXTURES SUPPLIED ARE APPROVED PER ALL
- APPLICABLE STATE, LOCAL AND GOVERNING AUTHORITIES. 4. ALL FIXTURES SHALL CONFORM TO FEDERAL ACT S.3874

INFORMATION

- 5. INVERT ELEVATIONS ARE FROM EXISTING DRAWINGS AND MAY NOT BE ACCURATE. VERIFY ALL ELEVATIONS BEFORE BEGINNING WORK.
- 6. VERIFY UNDERGROUND PIPE SIZES, INVERT ELEVATIONS, AND LOCATIONS PRIOR TO BEGINNING ANY WORK.
- 7. REFER TO THE PLUMBING ROUGH-IN SCHEDULE FOR THE SIZES OF BRANCH PIPES TO PLUMBING FIXTURES.
- 8. EXISTING CONDITIONS ON DEMOLITION PLANS ARE PROVIDED TO INDICATE THE GENERAL SCOPE OF ITEMS TO BE REMOVED. REFER TO SPECIFICATION SECTION 22 05 05 FOR ADDITIONAL DEMOLITION INFORMATION. 9. P.C. SHALL CUT AND PATCH EXISTING AS REQUIRED FOR NEW OR DEMOLITION WORK UNLESS NOTED OTHERWISE. REFER TO SPECIFICATION SECTION 22 05 05 FOR ADDITIONAL

	MEDICAL GAS MATERIAL	LIST
TAG NAME	DESCRIPTION	MANUFACTURER AND MODEL
MGO-1	MODULAR MEDICAL GAS OUTLET GROUP WHICH WILL CONTAIN THE FOLLOWING MEDICAL GAS OUTLETS: 1 OXYGEN (O) OUTLET(S) 1 MEDICAL AIR (MA) OUTLET(S) 1 VACUUM (MV) INLET(S) 1 NITROGEN (N) OUTLET(S) 1 CARBON DIOXIDE (CO2) OUTLET(S) 1 WASTE ANESTHETIC GAS DISPOSAL (WAGD) INLET(S). REFER TO 'OUTLETS' FOR ADDITIONAL INFORMATION.	BEACONMEDAES, OHIO MEDICAL, PATTONS MEDICAL, TRI-TECH, AMICO, POWEREX
OUTLET	MEDICAL GAS SERVICE OUTLET - RECESSED DISS TYPE WALL OUTLET FOR ALL OUTLETS OTHER THAN CARBON DIOXIDE QUICK CONNECT TYPE FOR CARBON DIOXIED. ROUGHING IN ASSEMBLY AND FINISH ASSEMBLY, MOUNTING FLANGES, PLASTER STRIKE, SECONDARY CHECK, 3/8" O.D. TYPE K COPPER INLET TUBE, LABEL IDENTIFYING SPECIFIC GAS BY NAME AND COLOR, BRUSHED STAINLESS STEEL FINISHING PLATE. [RENOVATION/EXISTING PROJECTS: VERIFY THE CONNECTION STYLE OF MEDICAL GAS OUTLET IS COMPATIBLE WITH EQUIPMENT USED IN THE FACILITY.] SYMBOLS FOR OUTLETS ARE AS FOLLOWS:	AMICO
	O OXYGEN A MEDICAL AIR VAC VACUUM N NITROGEN CO CARBON DIOXIDE NO NITROUS OXIDE WAGD WASTE ANESTHETIC GAS DISPOSAL	
	DISS CONNECTION TYPE ARE REQUIRED FOR NITROGEN OUTLETS.	
	PROVIDE ONE VACUUM SLIDE ASSEMBLY WITH EACH VACUUM SERVICE	
	ALL OUTLETS SHALL BE OXEQUIP-MED*STAR STYLE.	

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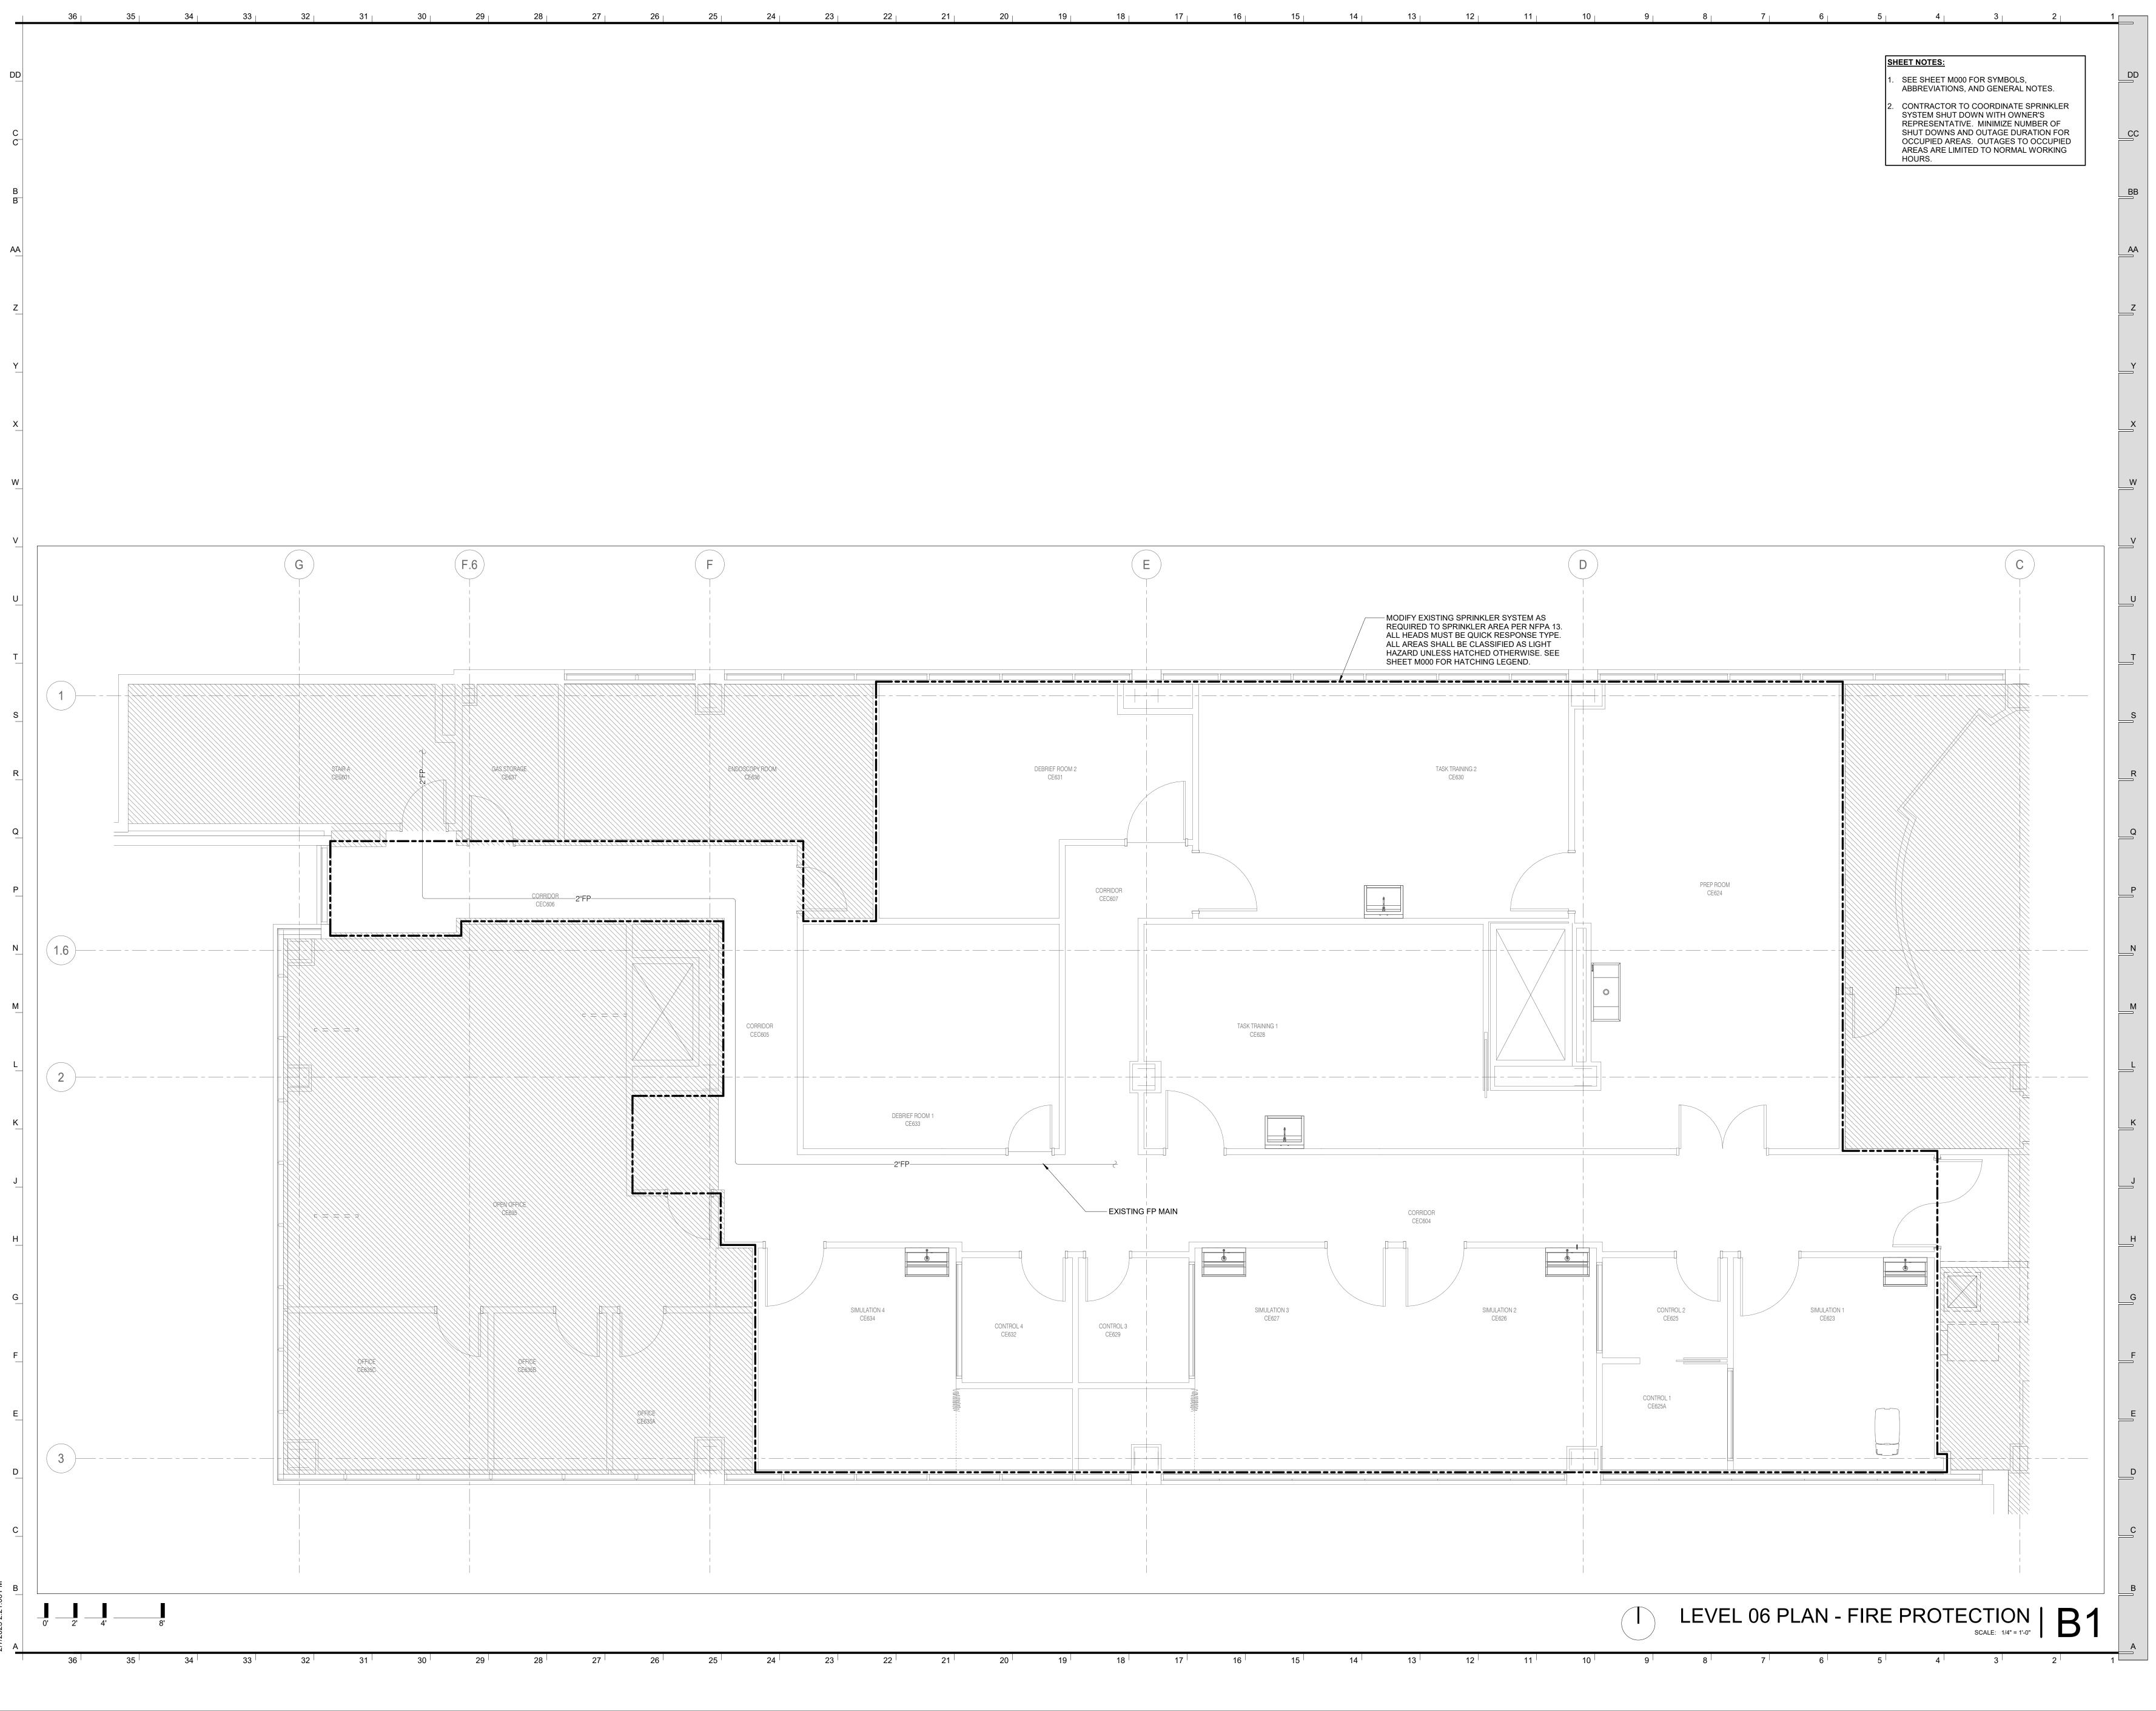
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LEVEL 06 PLAN - FIRE PROTECTION F206

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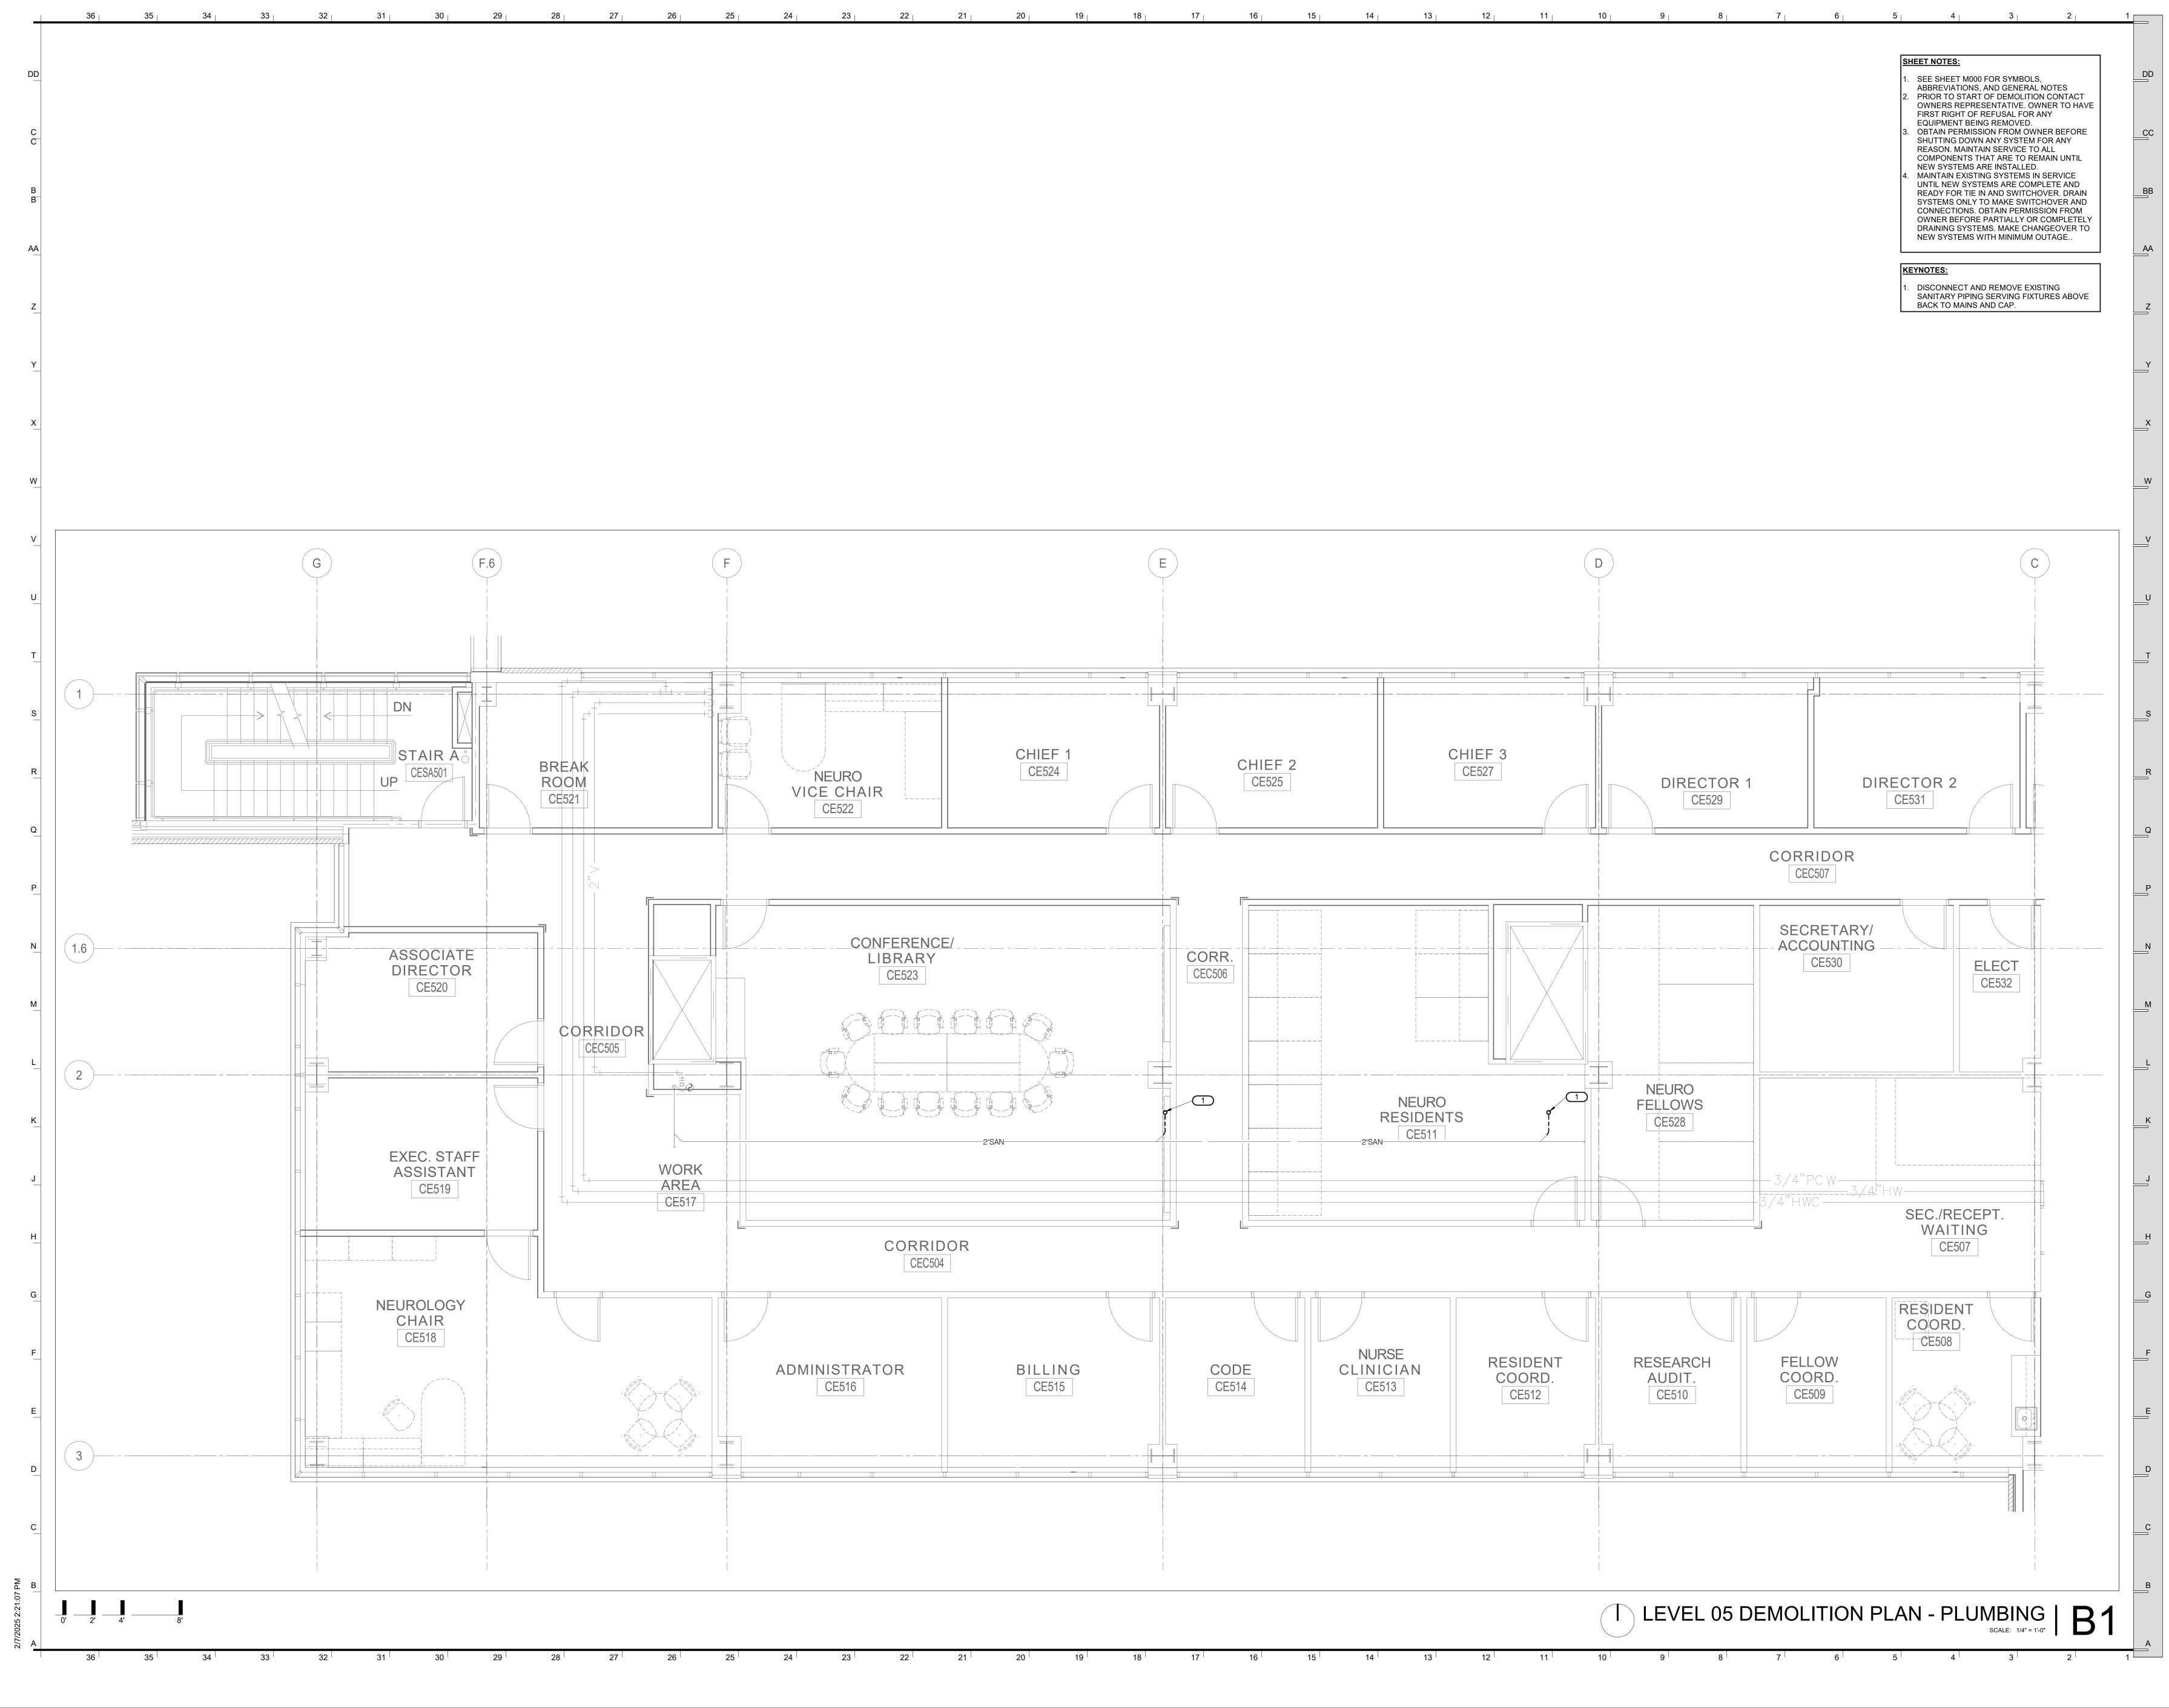
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LEVEL 05 **DEMOLITION PLAN -**PLUMBING P105

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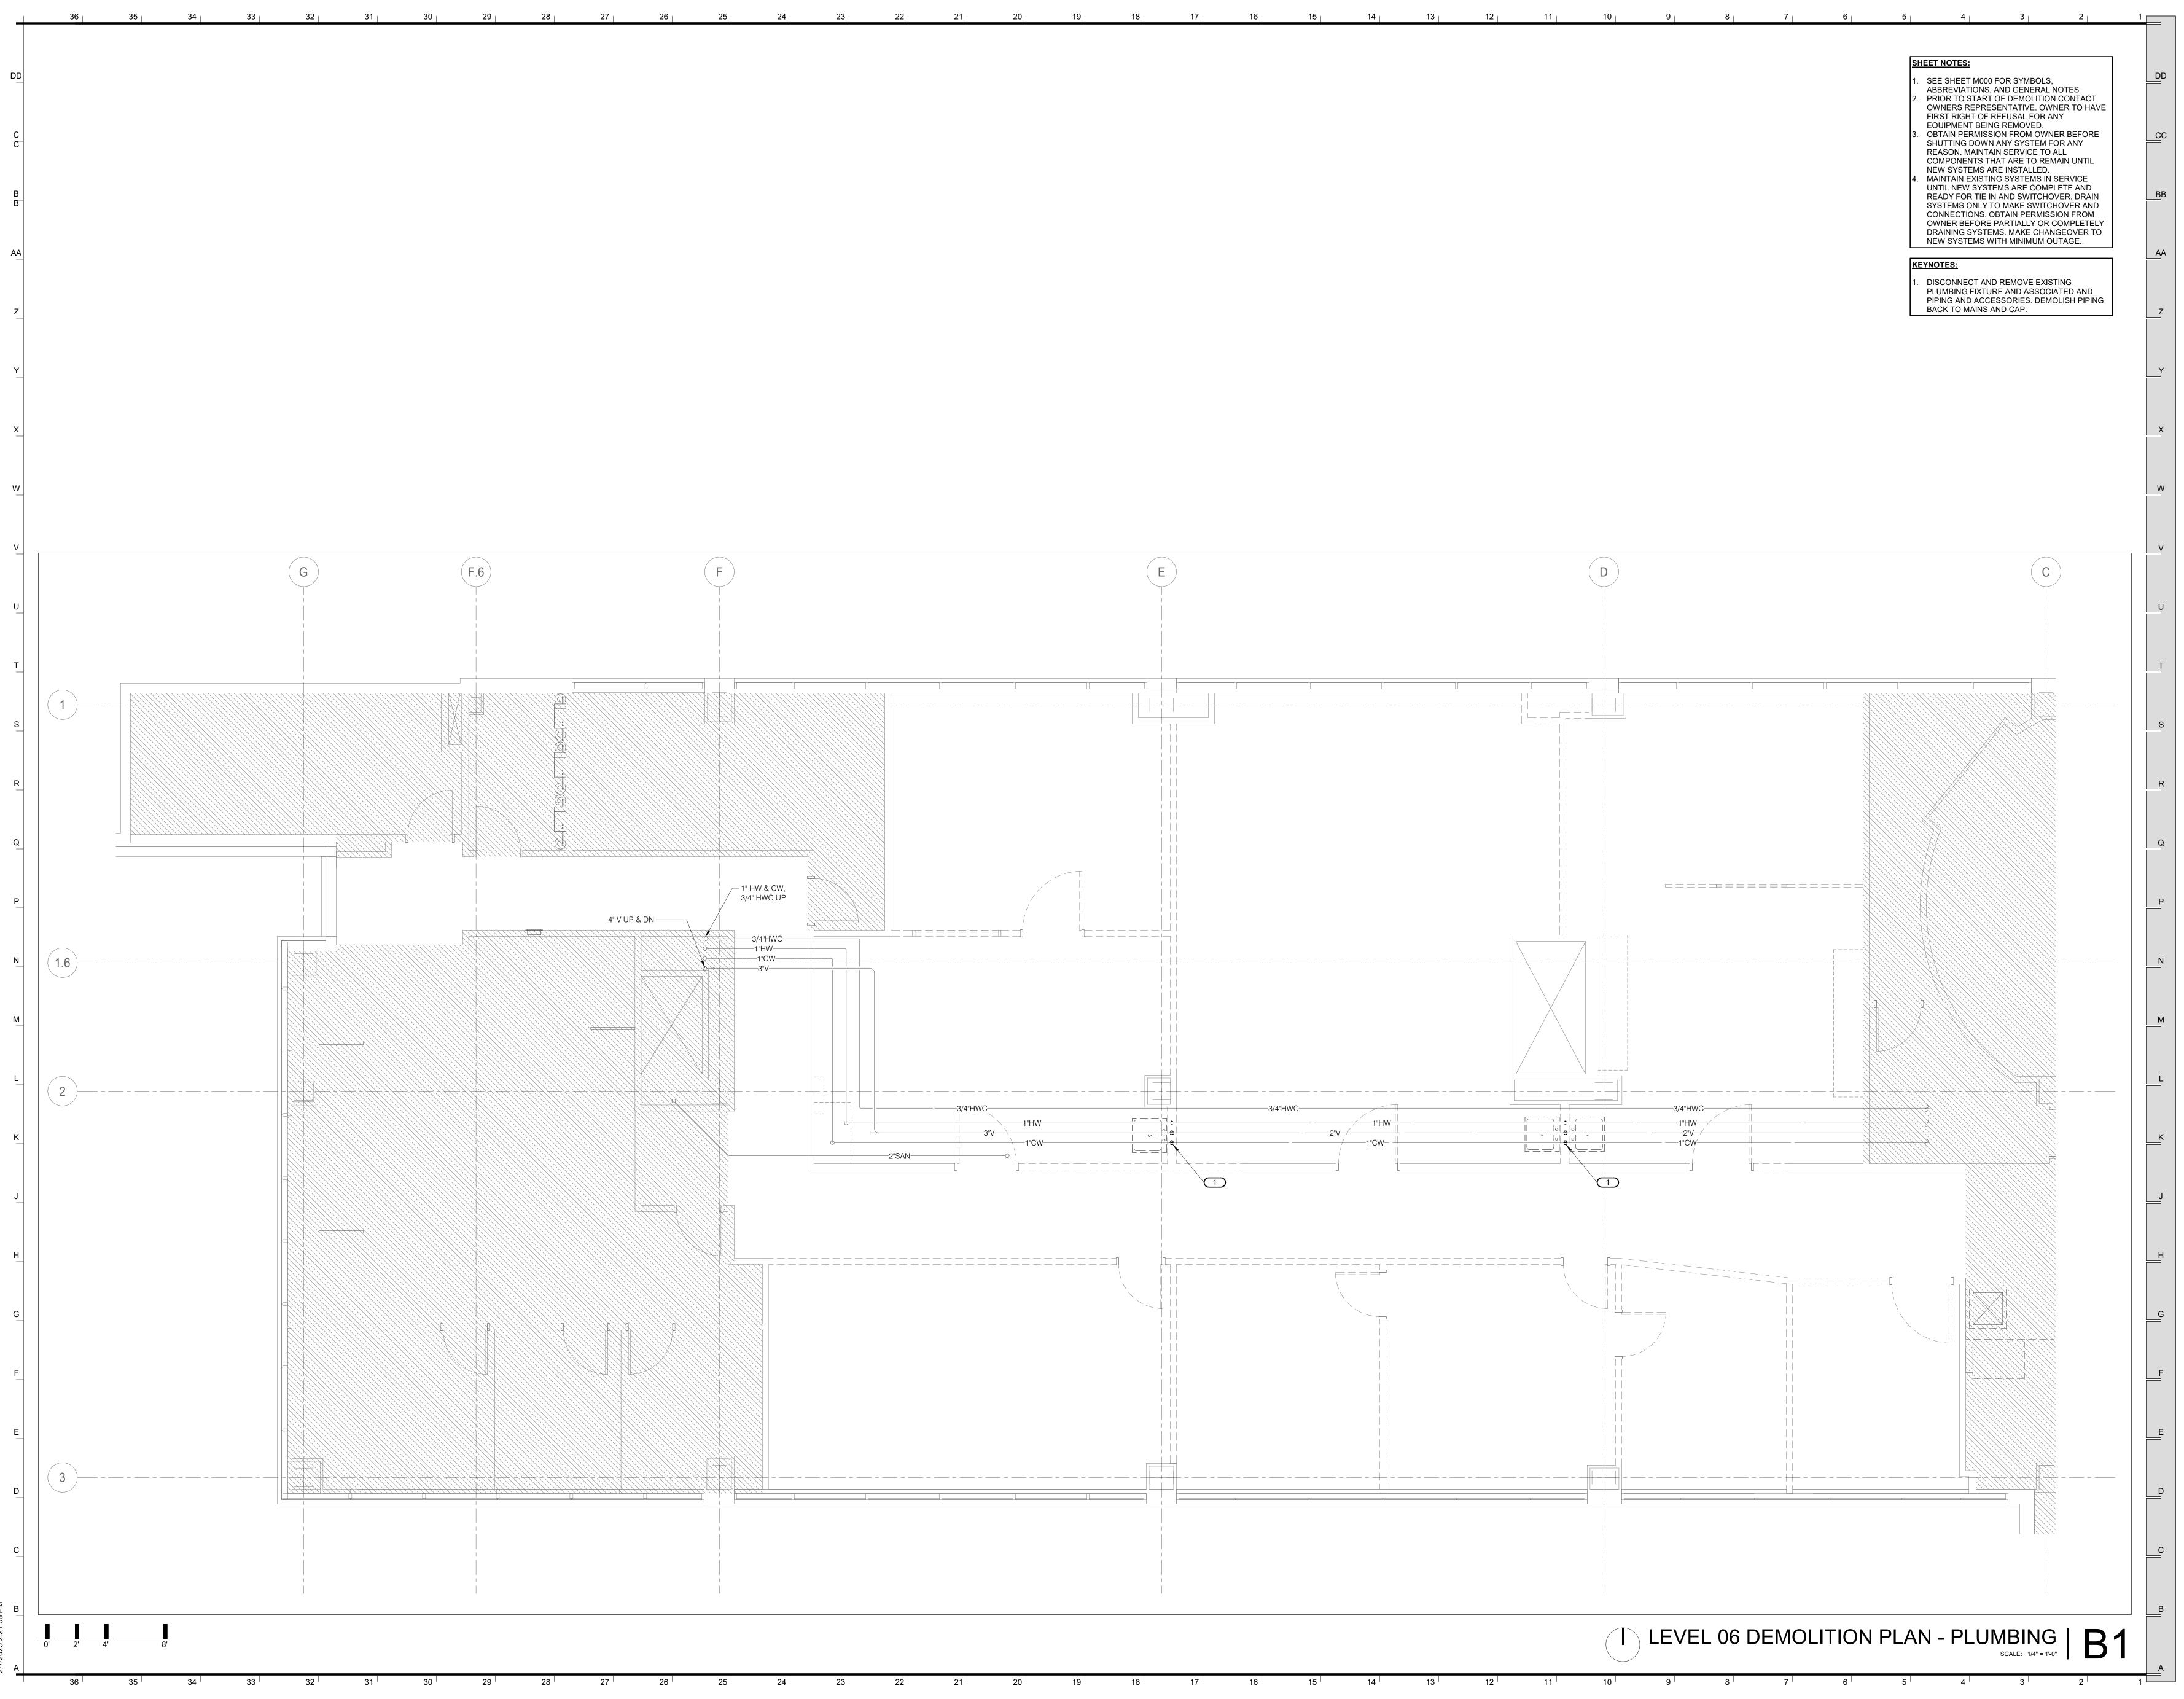
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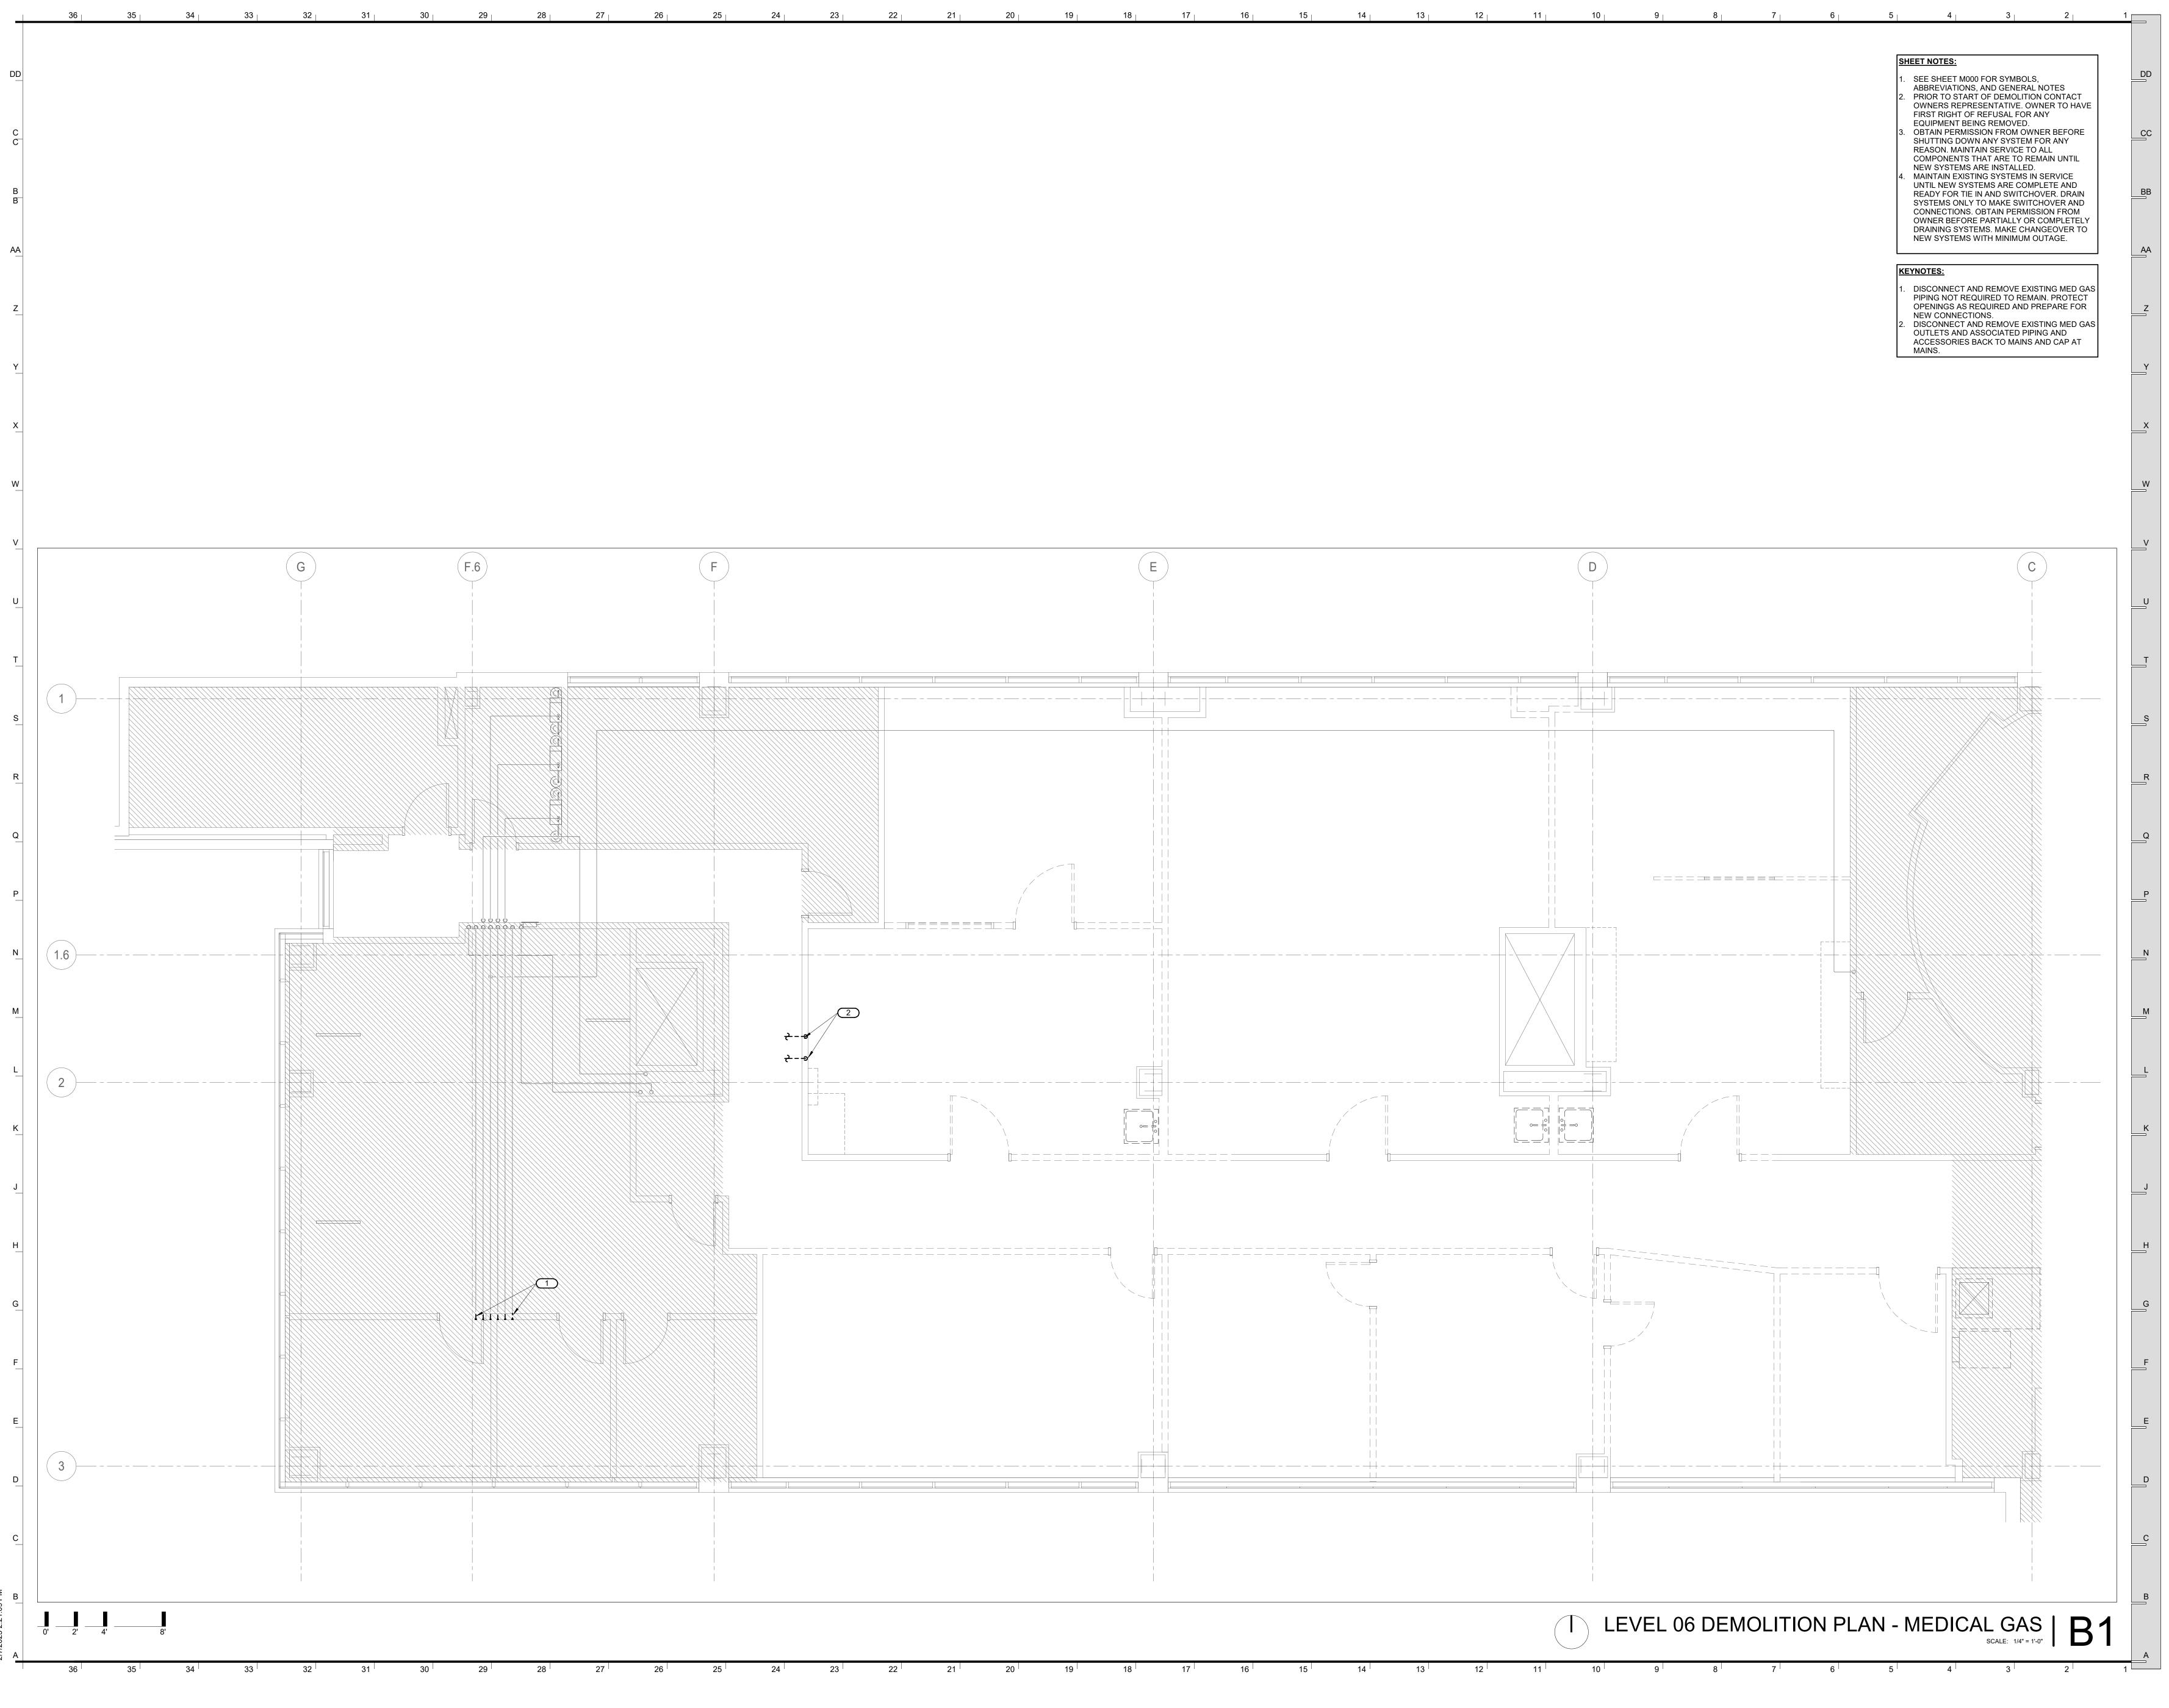
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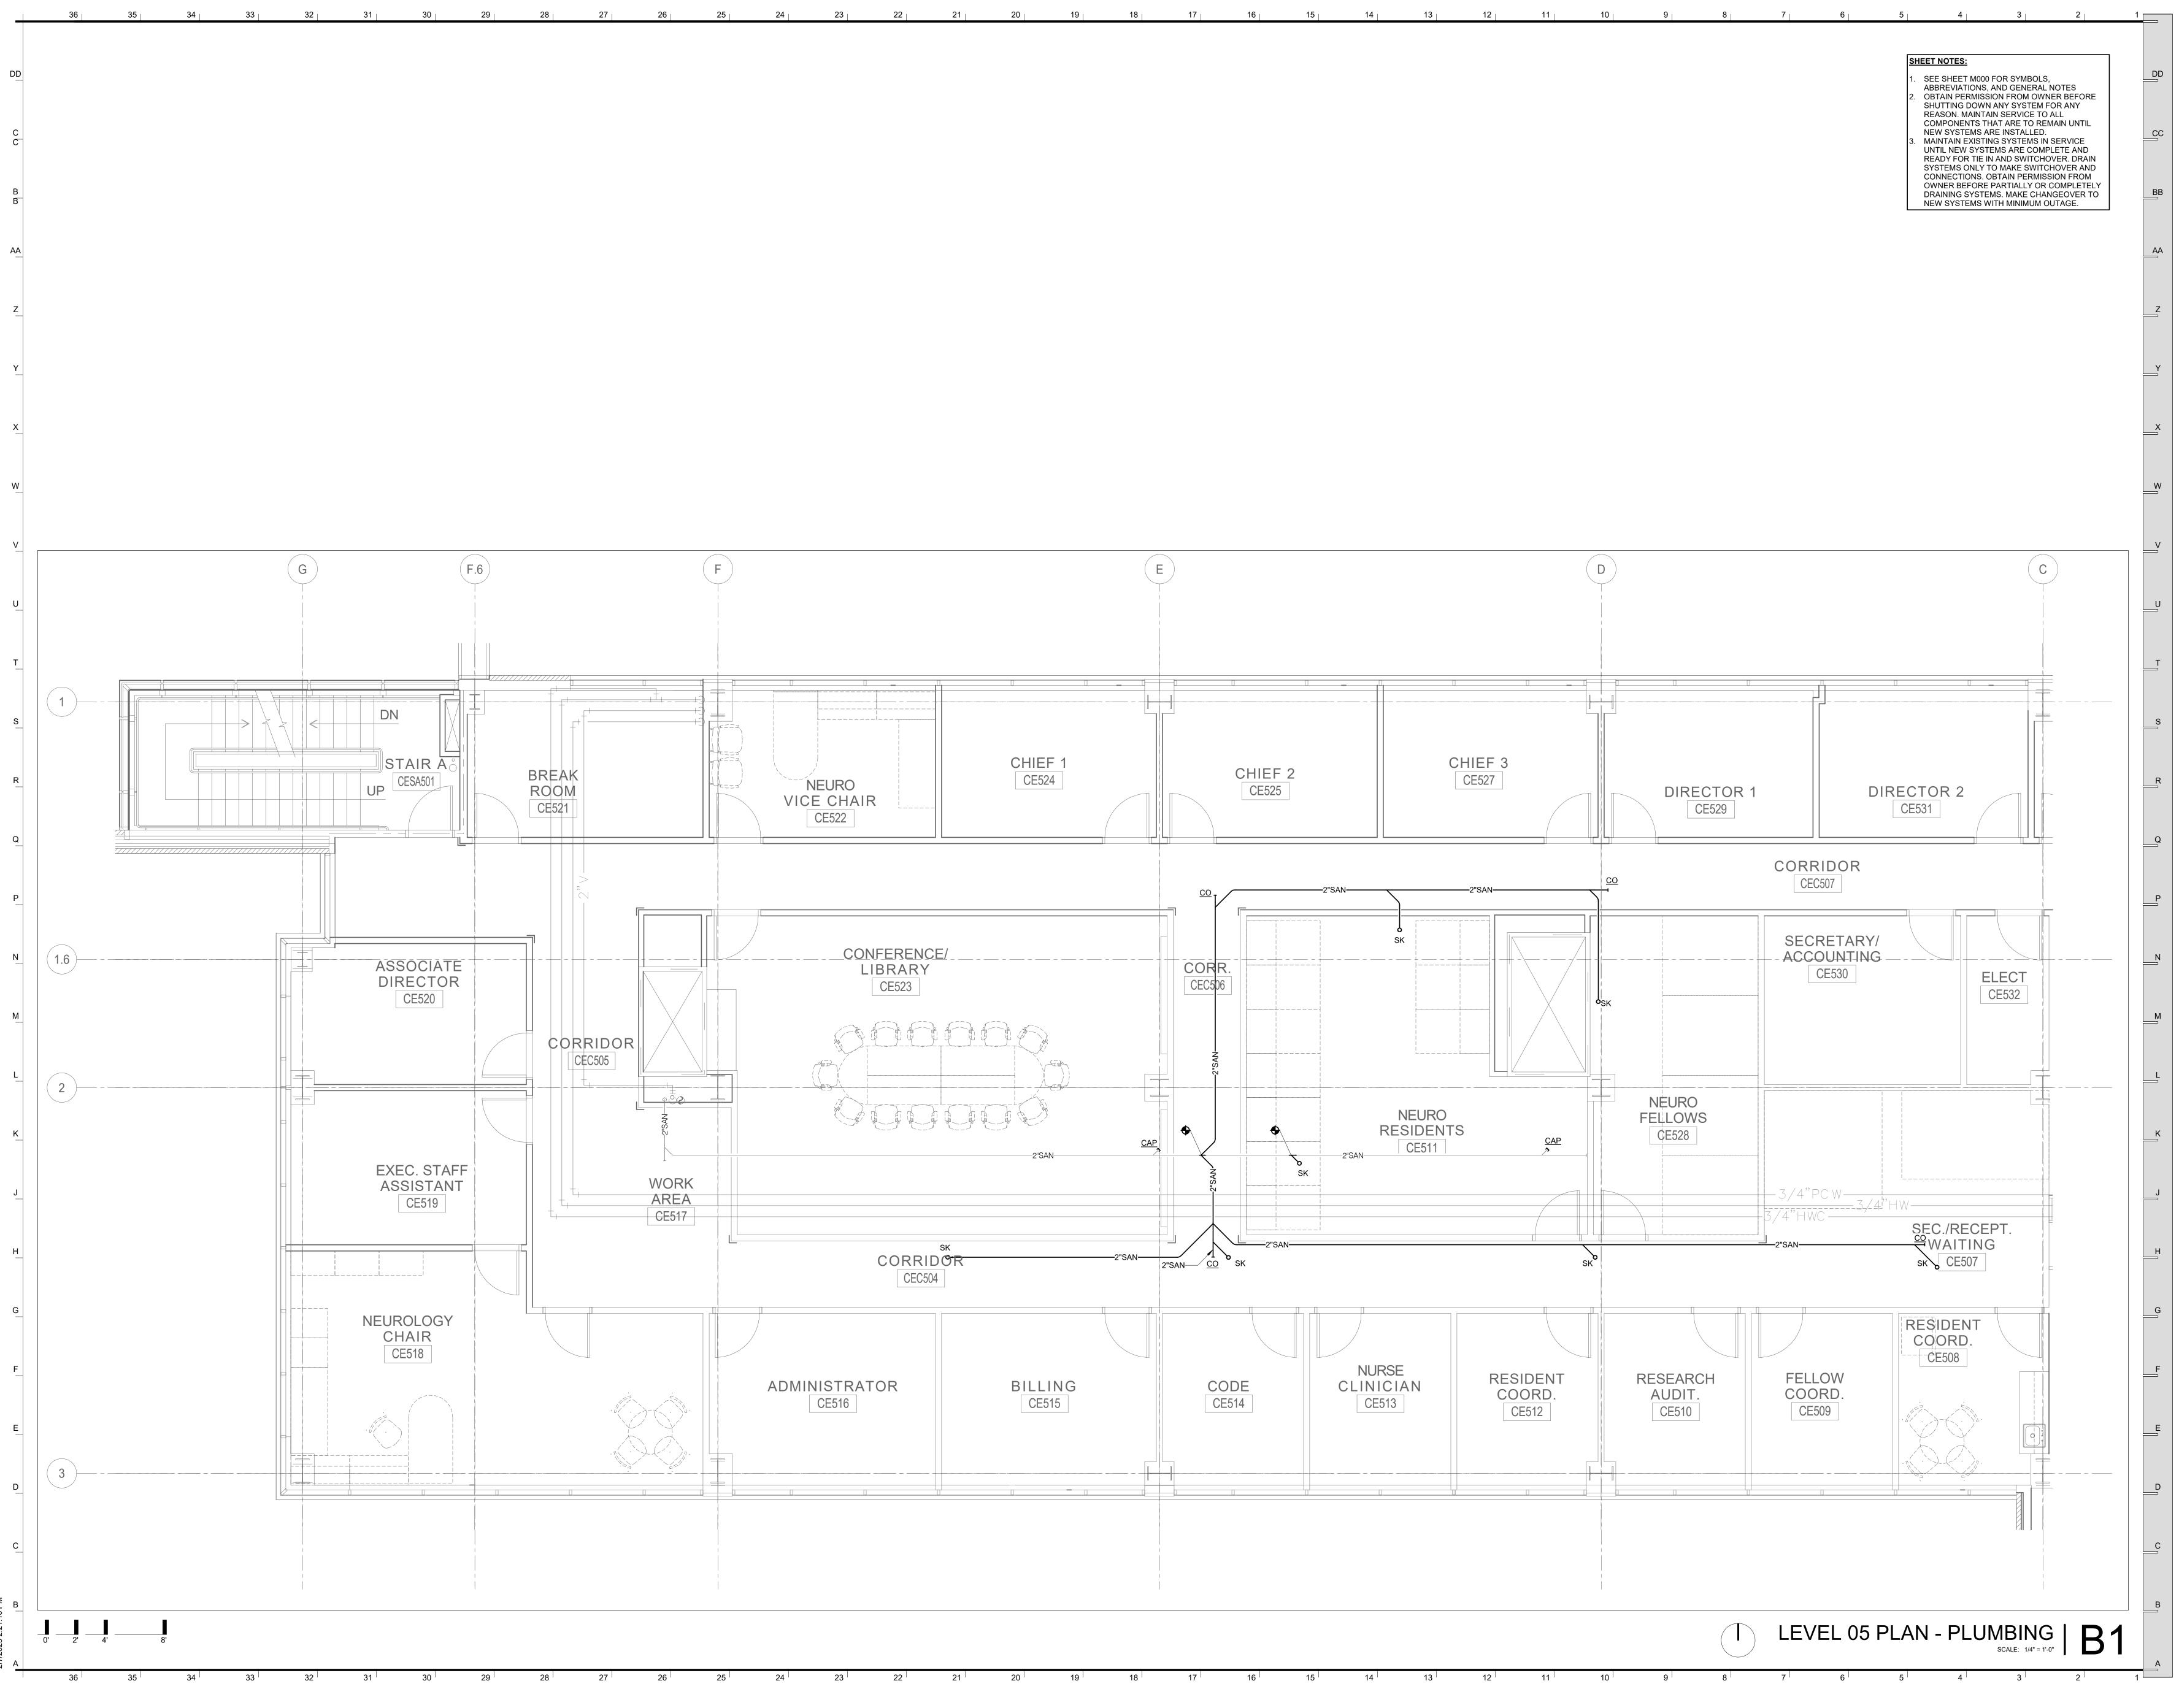
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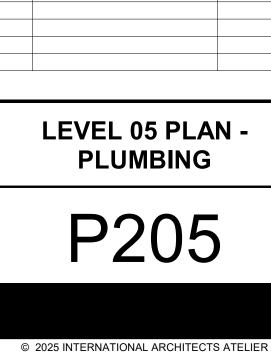
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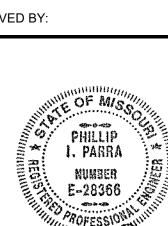
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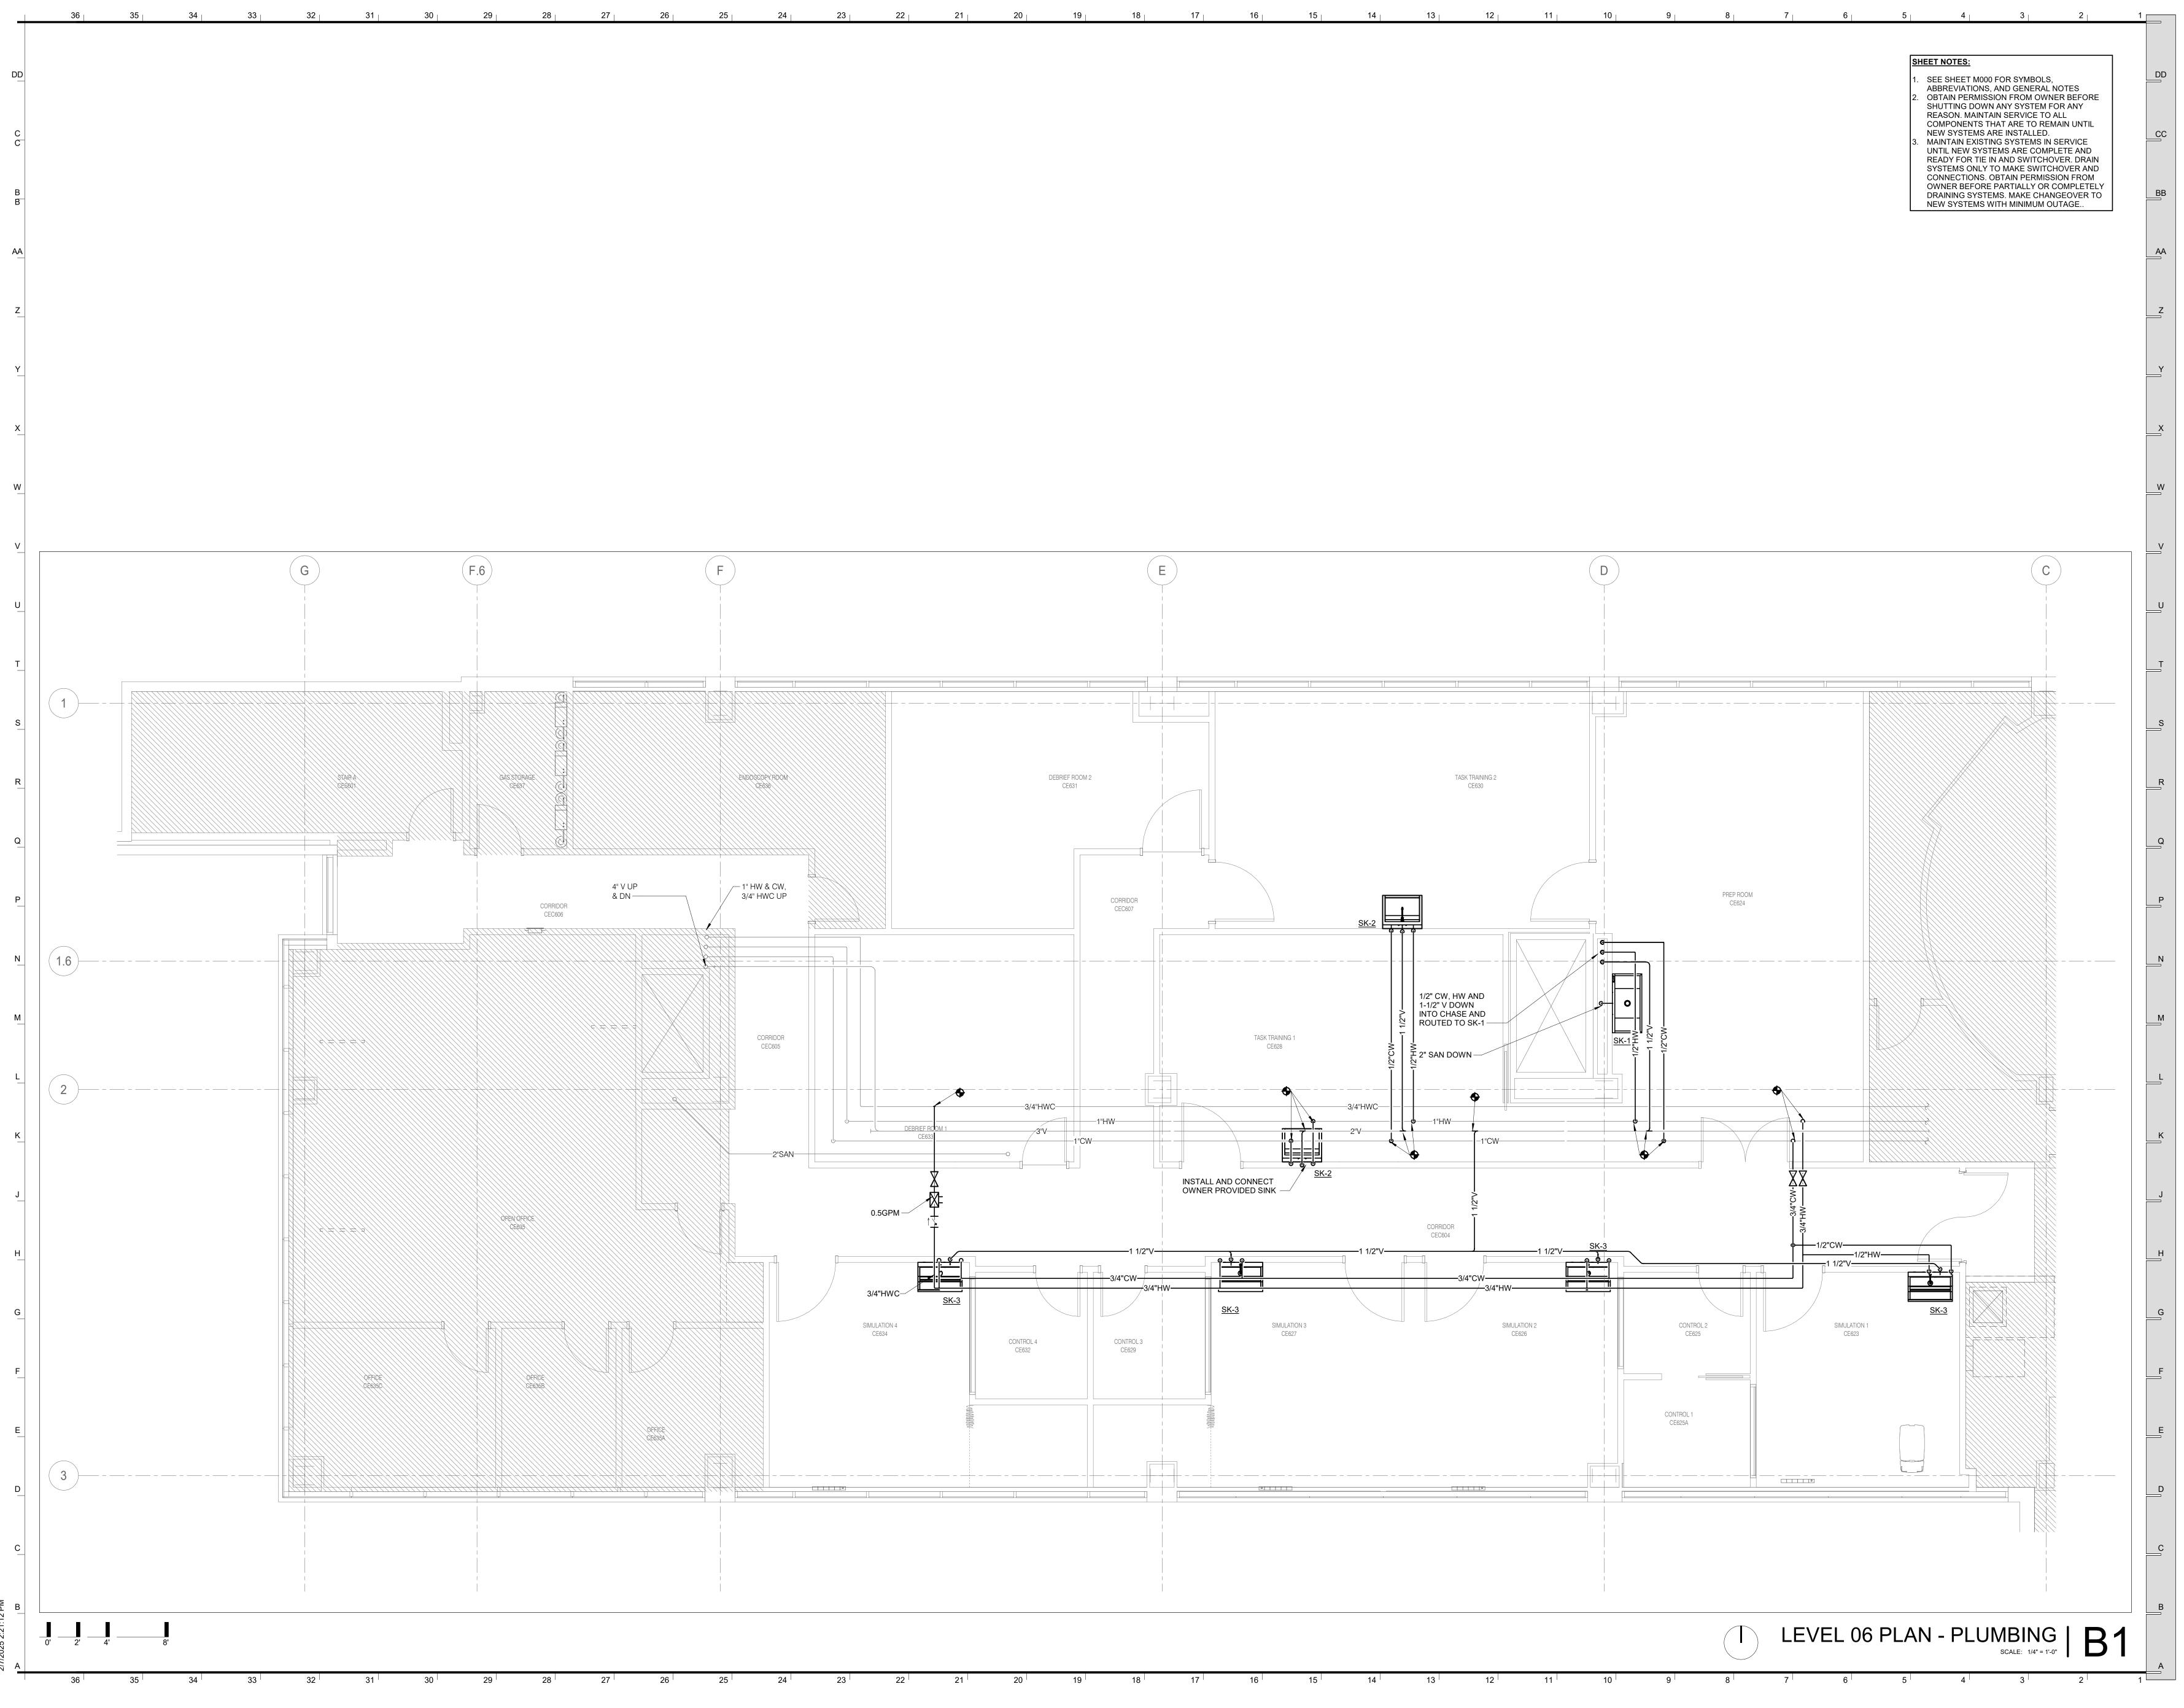
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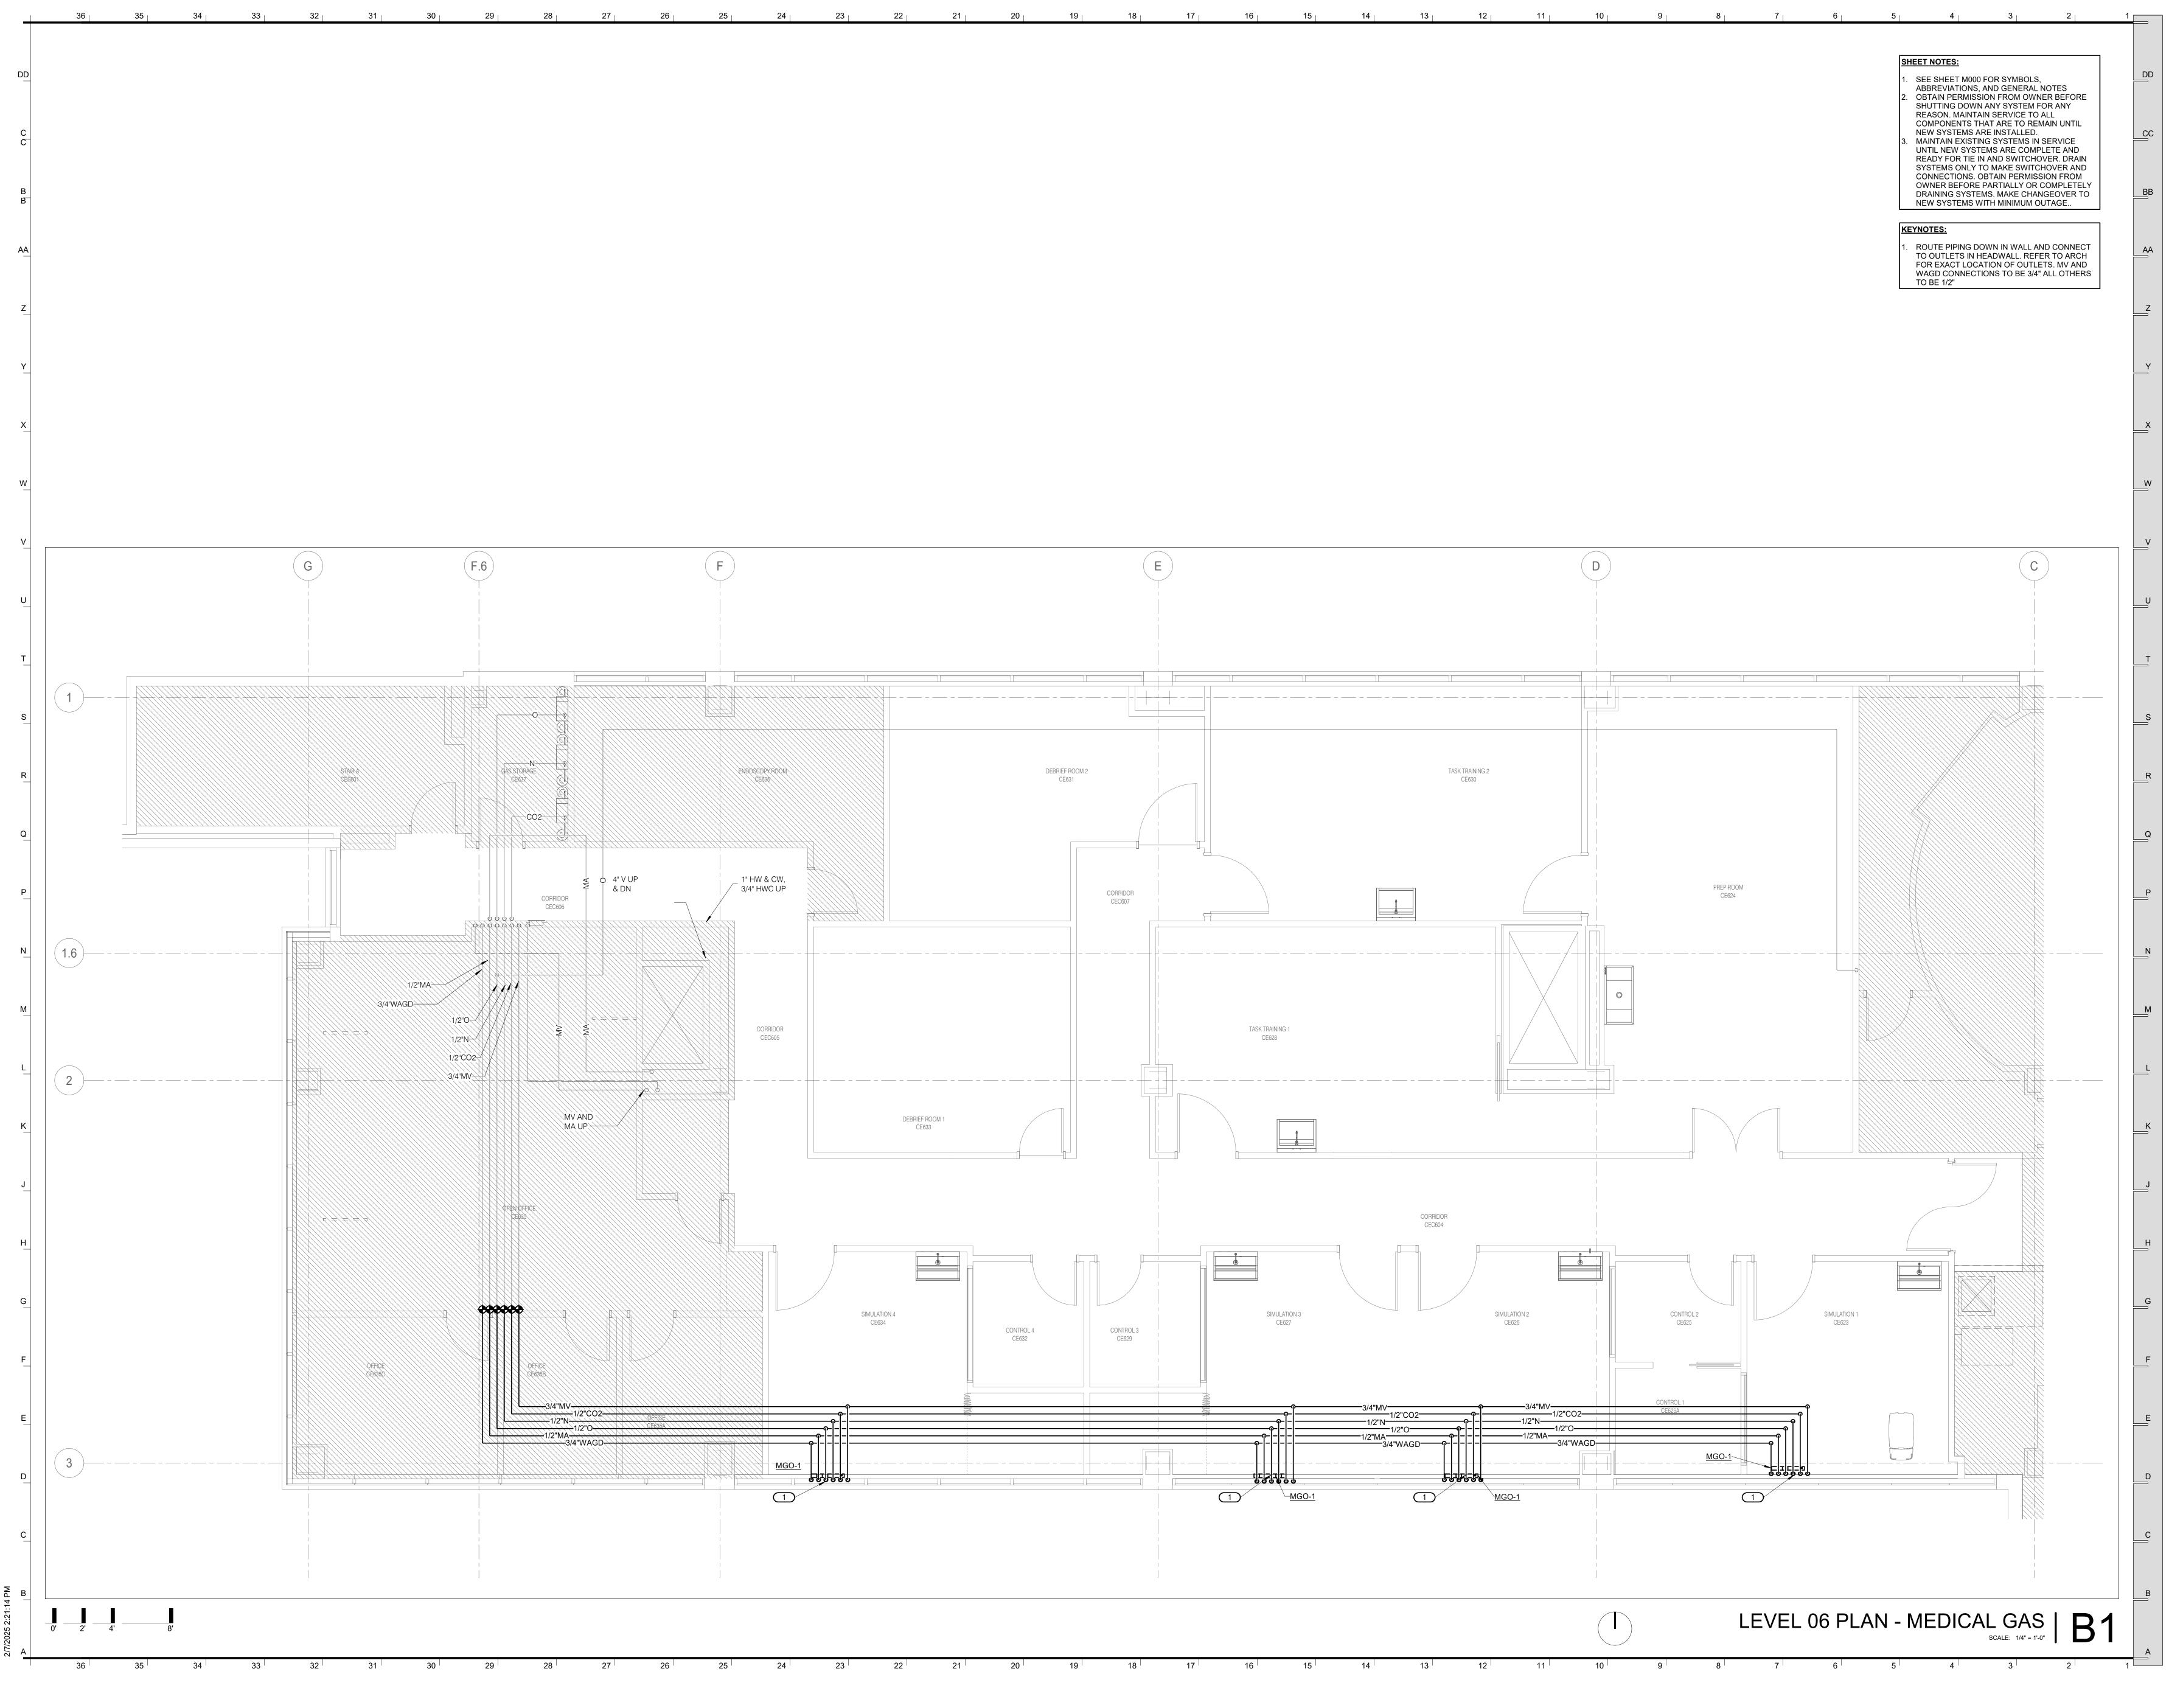
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. PARRA

NUMBER E-28366

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PHILLIP I. PARRA - ENGINEER MO#: E-28366

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LEVEL 06 PLAN -MEDICAL GAS

P216

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PHASE II

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1600 BALTIMORE, SUITE 300 KANSAS CITY, MO 64108 PH: 816.842.8437

IMEG CORP.


MEP CONSULTANT

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INTERNATIONAL ARCHITECTS ATELIER 912 BROADWAY BLVD, SUITE 300 | KANSAS CITY, MO 64105



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M106

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[LEVEL 06 DEMOLITION PI	LAN -
	PIPING	
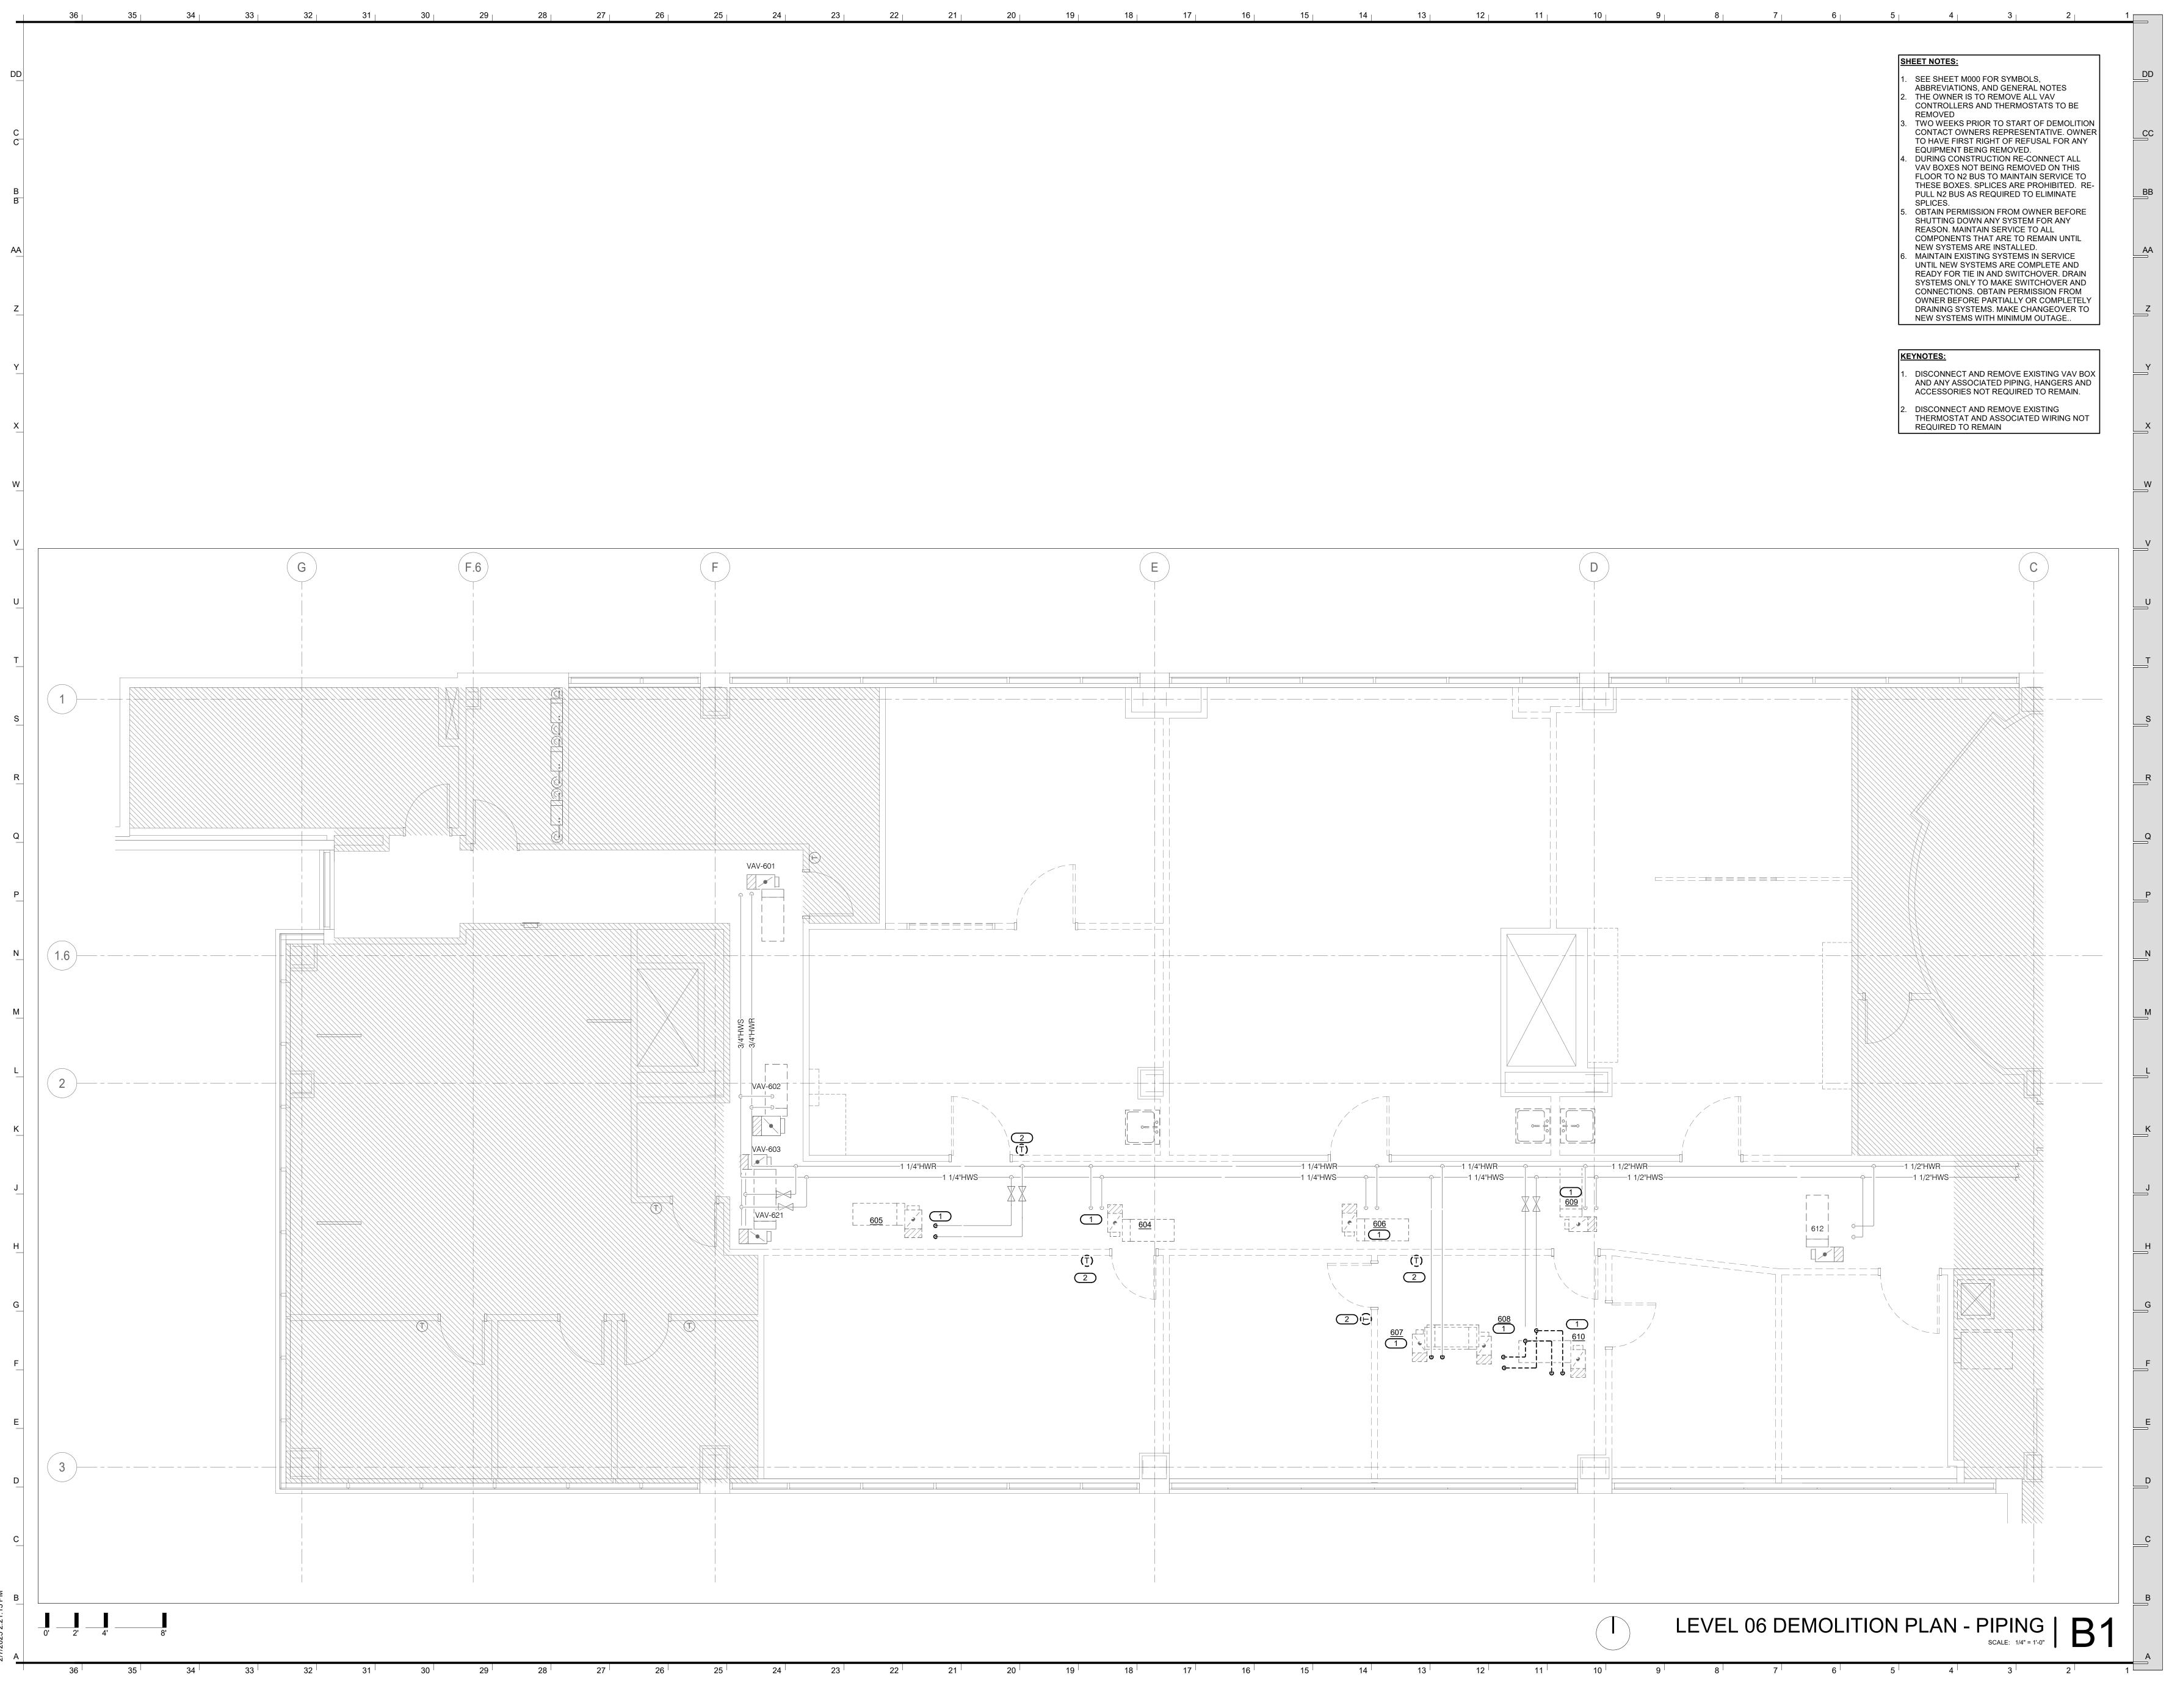
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PHILLIP I. PARRA - ENGINEER MO#: E-28366

SEAL:		
	PHILLIP PHILLIP I. PARRA E-28366	
	PHILLIP	
	NUMBER /	

02/21/2025 CP250271

CSB

CSB

SGB

SGB

02-21-2025

5 HOSPITAL DR. COLUMBIA, MO 65201

DATE:

PROJ. NO.:

DESIGNED BY:

DRAWN BY:

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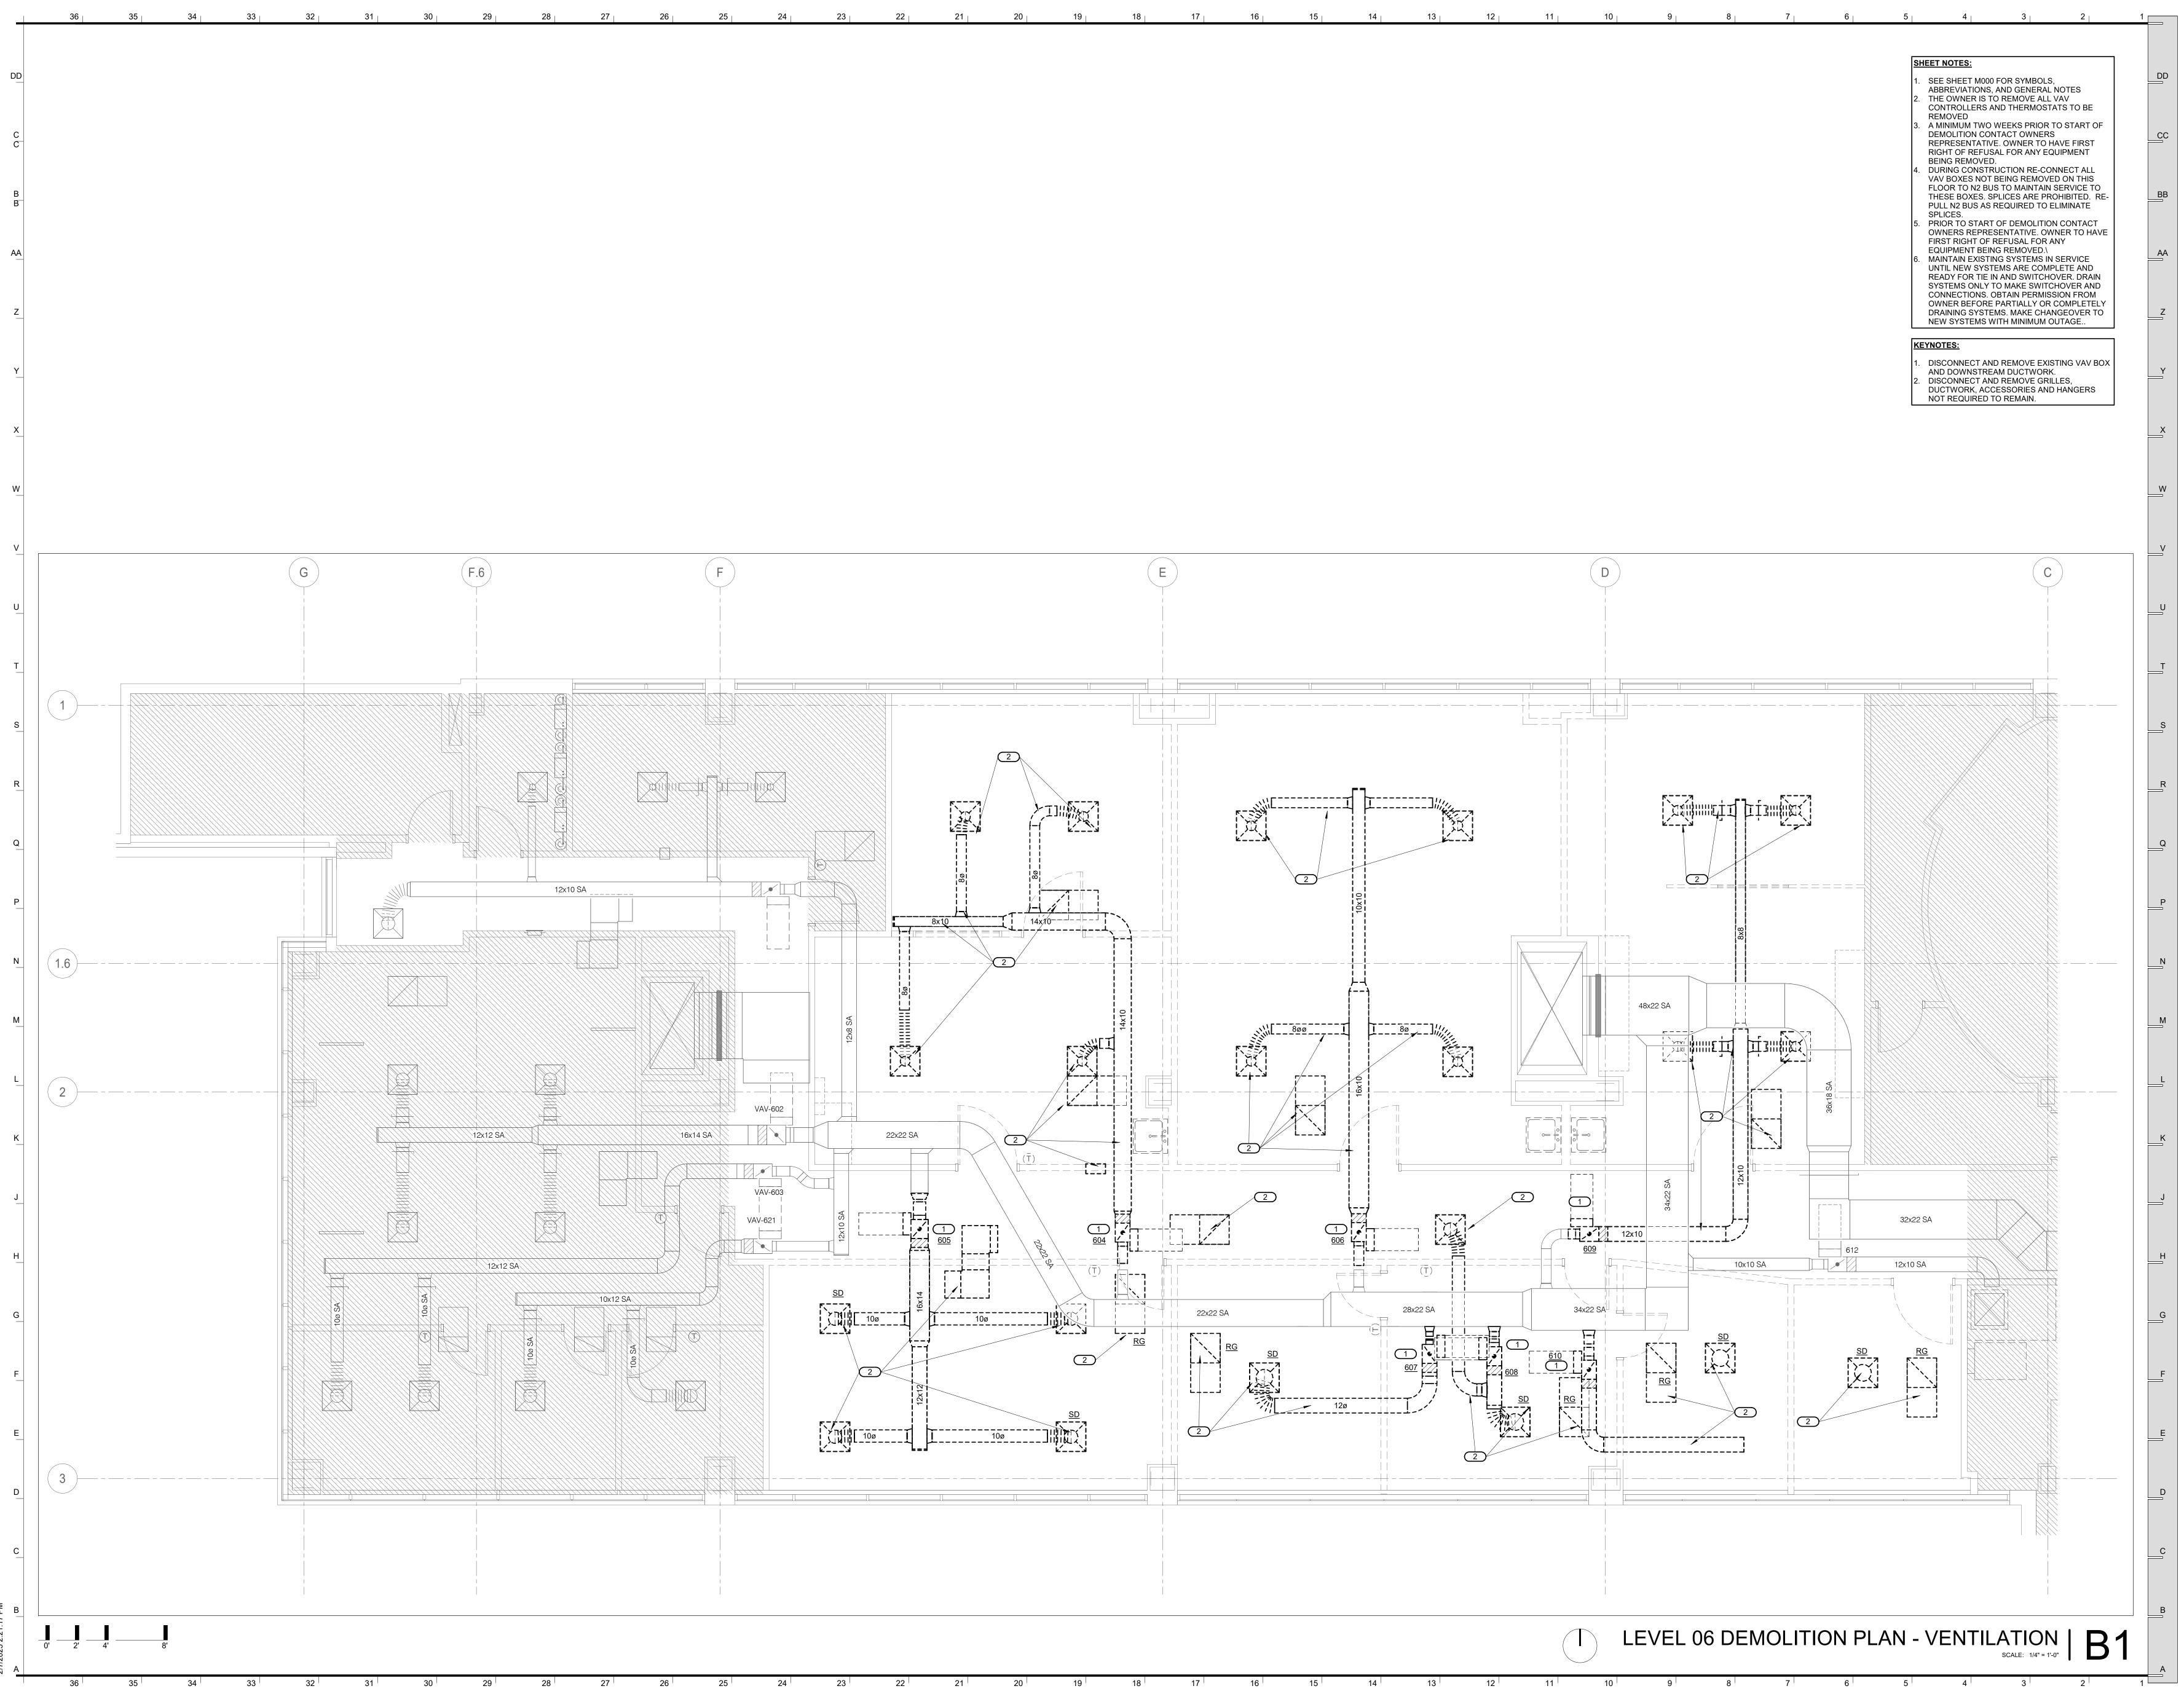
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LEVEL 06 **DEMOLITION PLAN -**VENTILATION M116

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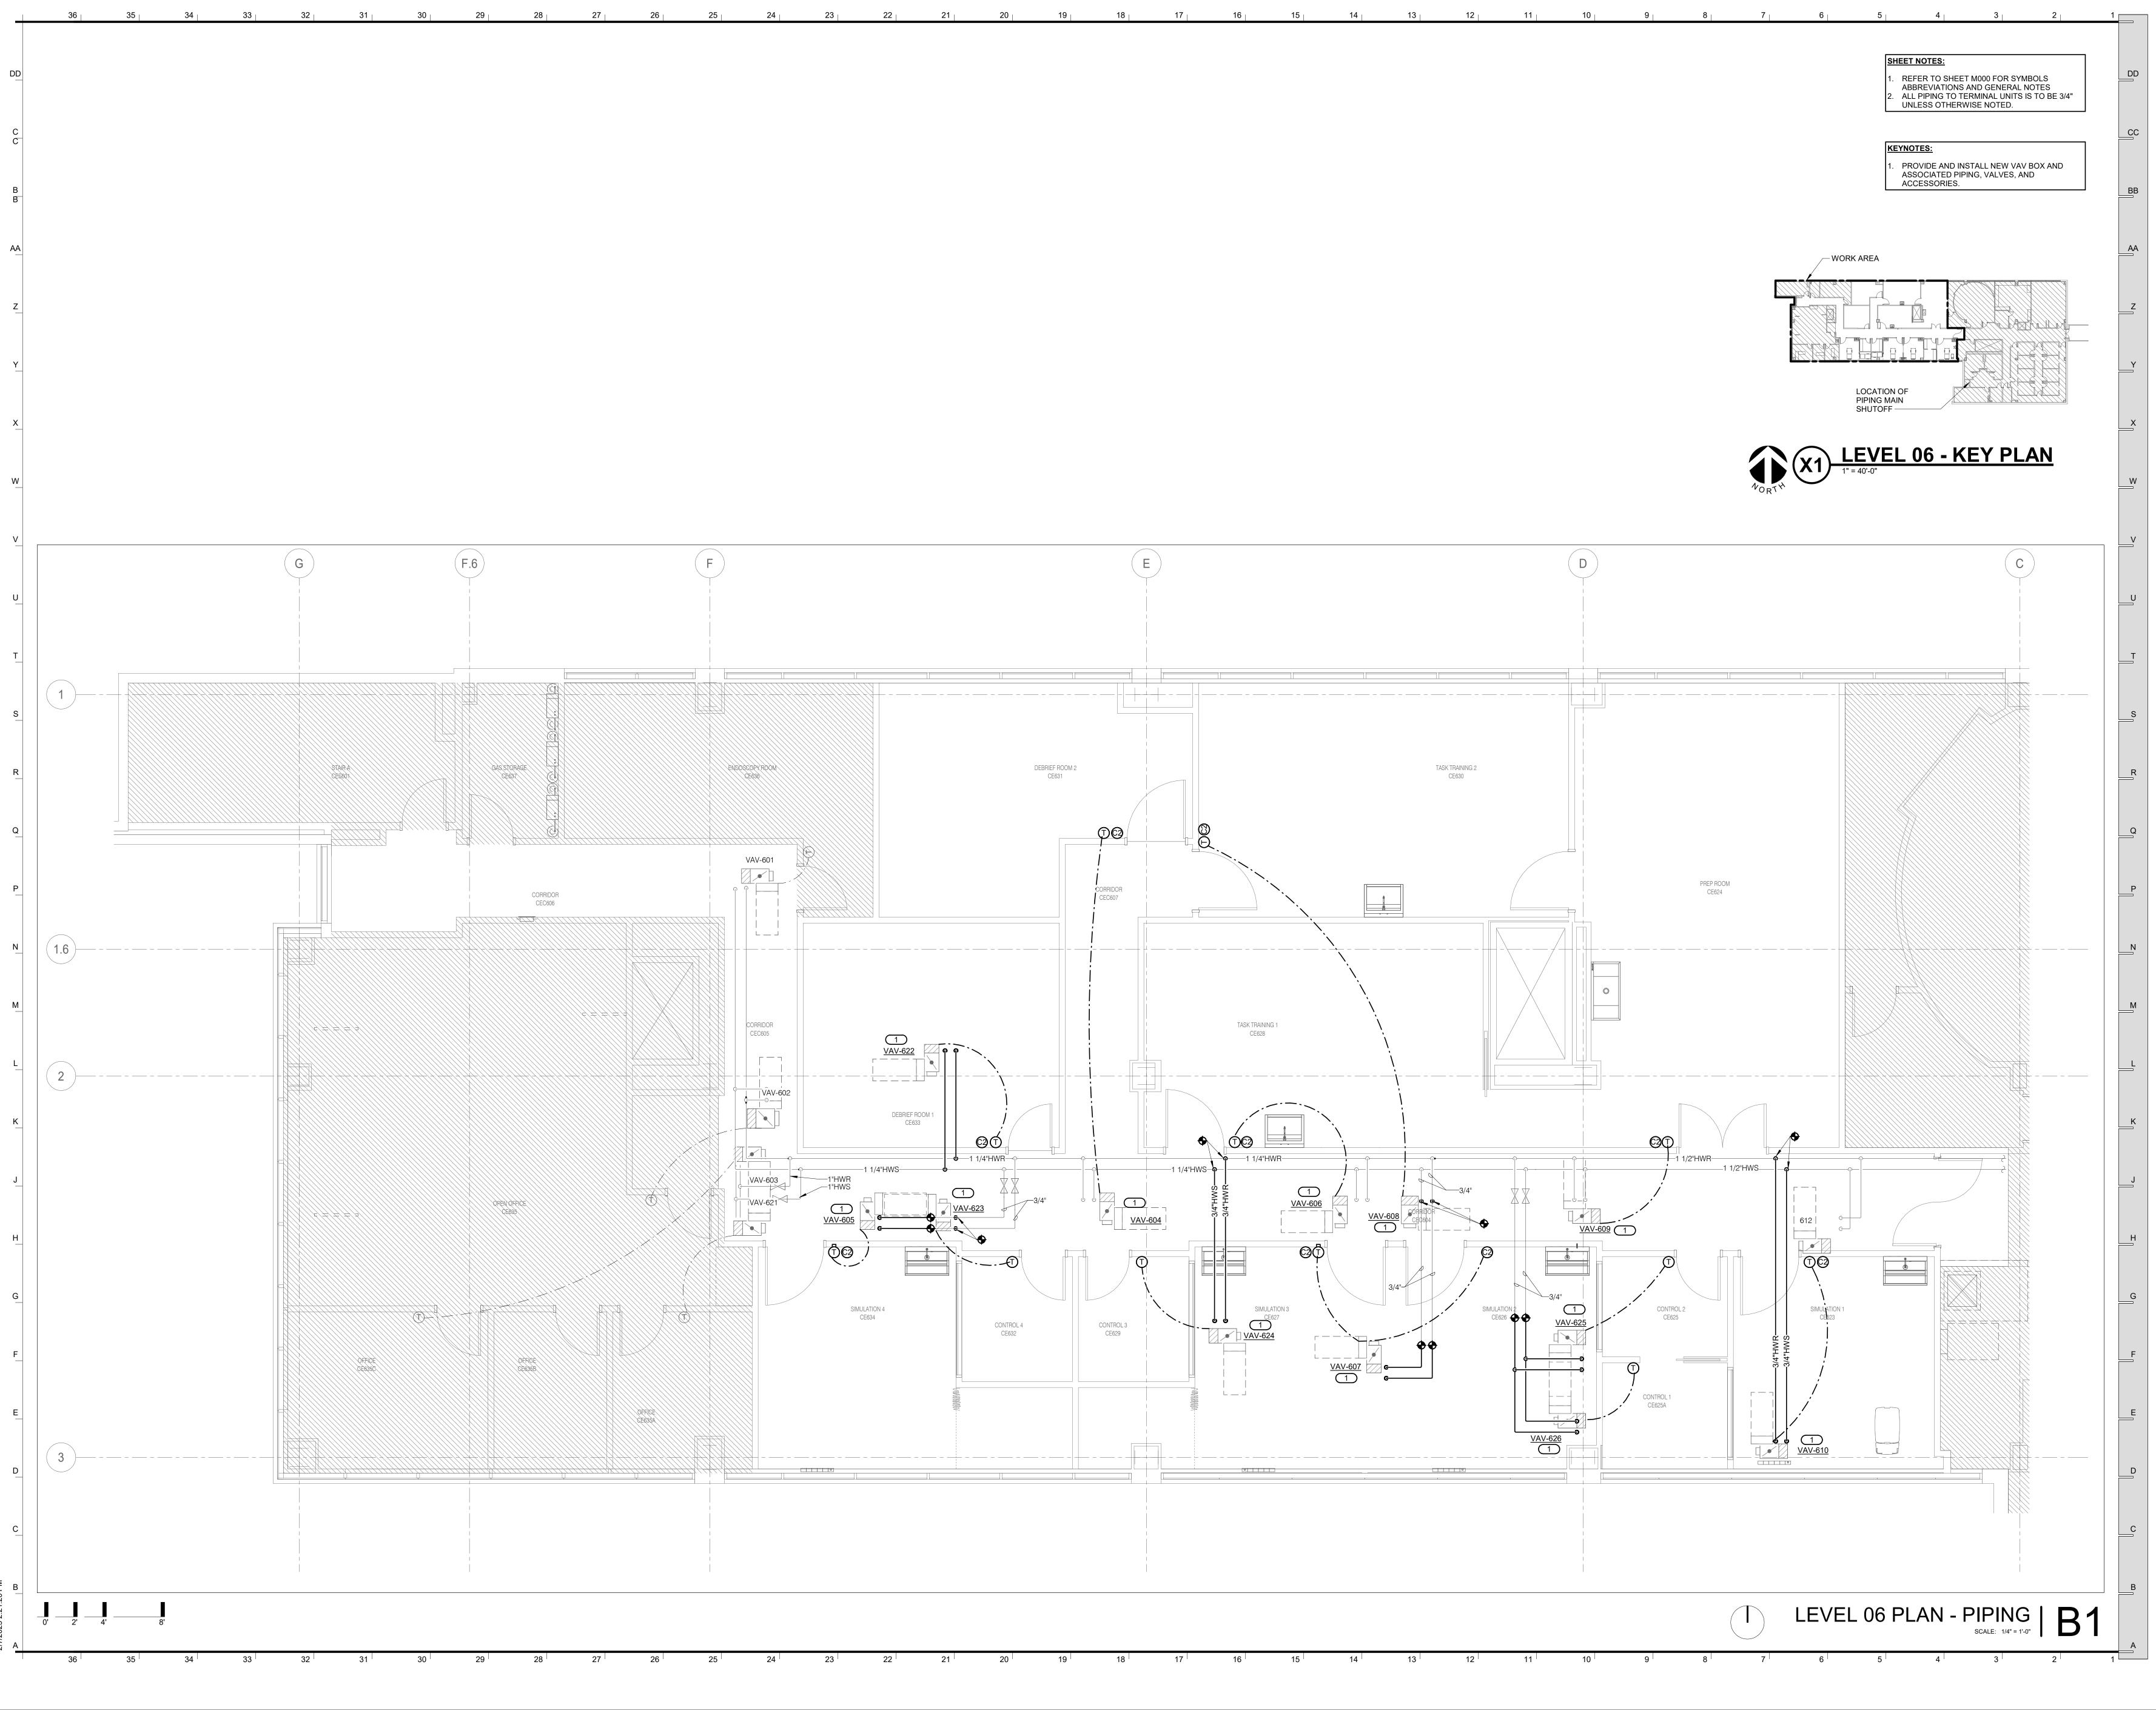
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M206

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MUL >> 02-21-2025 PHILLIP I. PARRA - ENGINEER MO#: E-28366

APPROVED BY: SGB SEAL:

, PARRA

NUMBER

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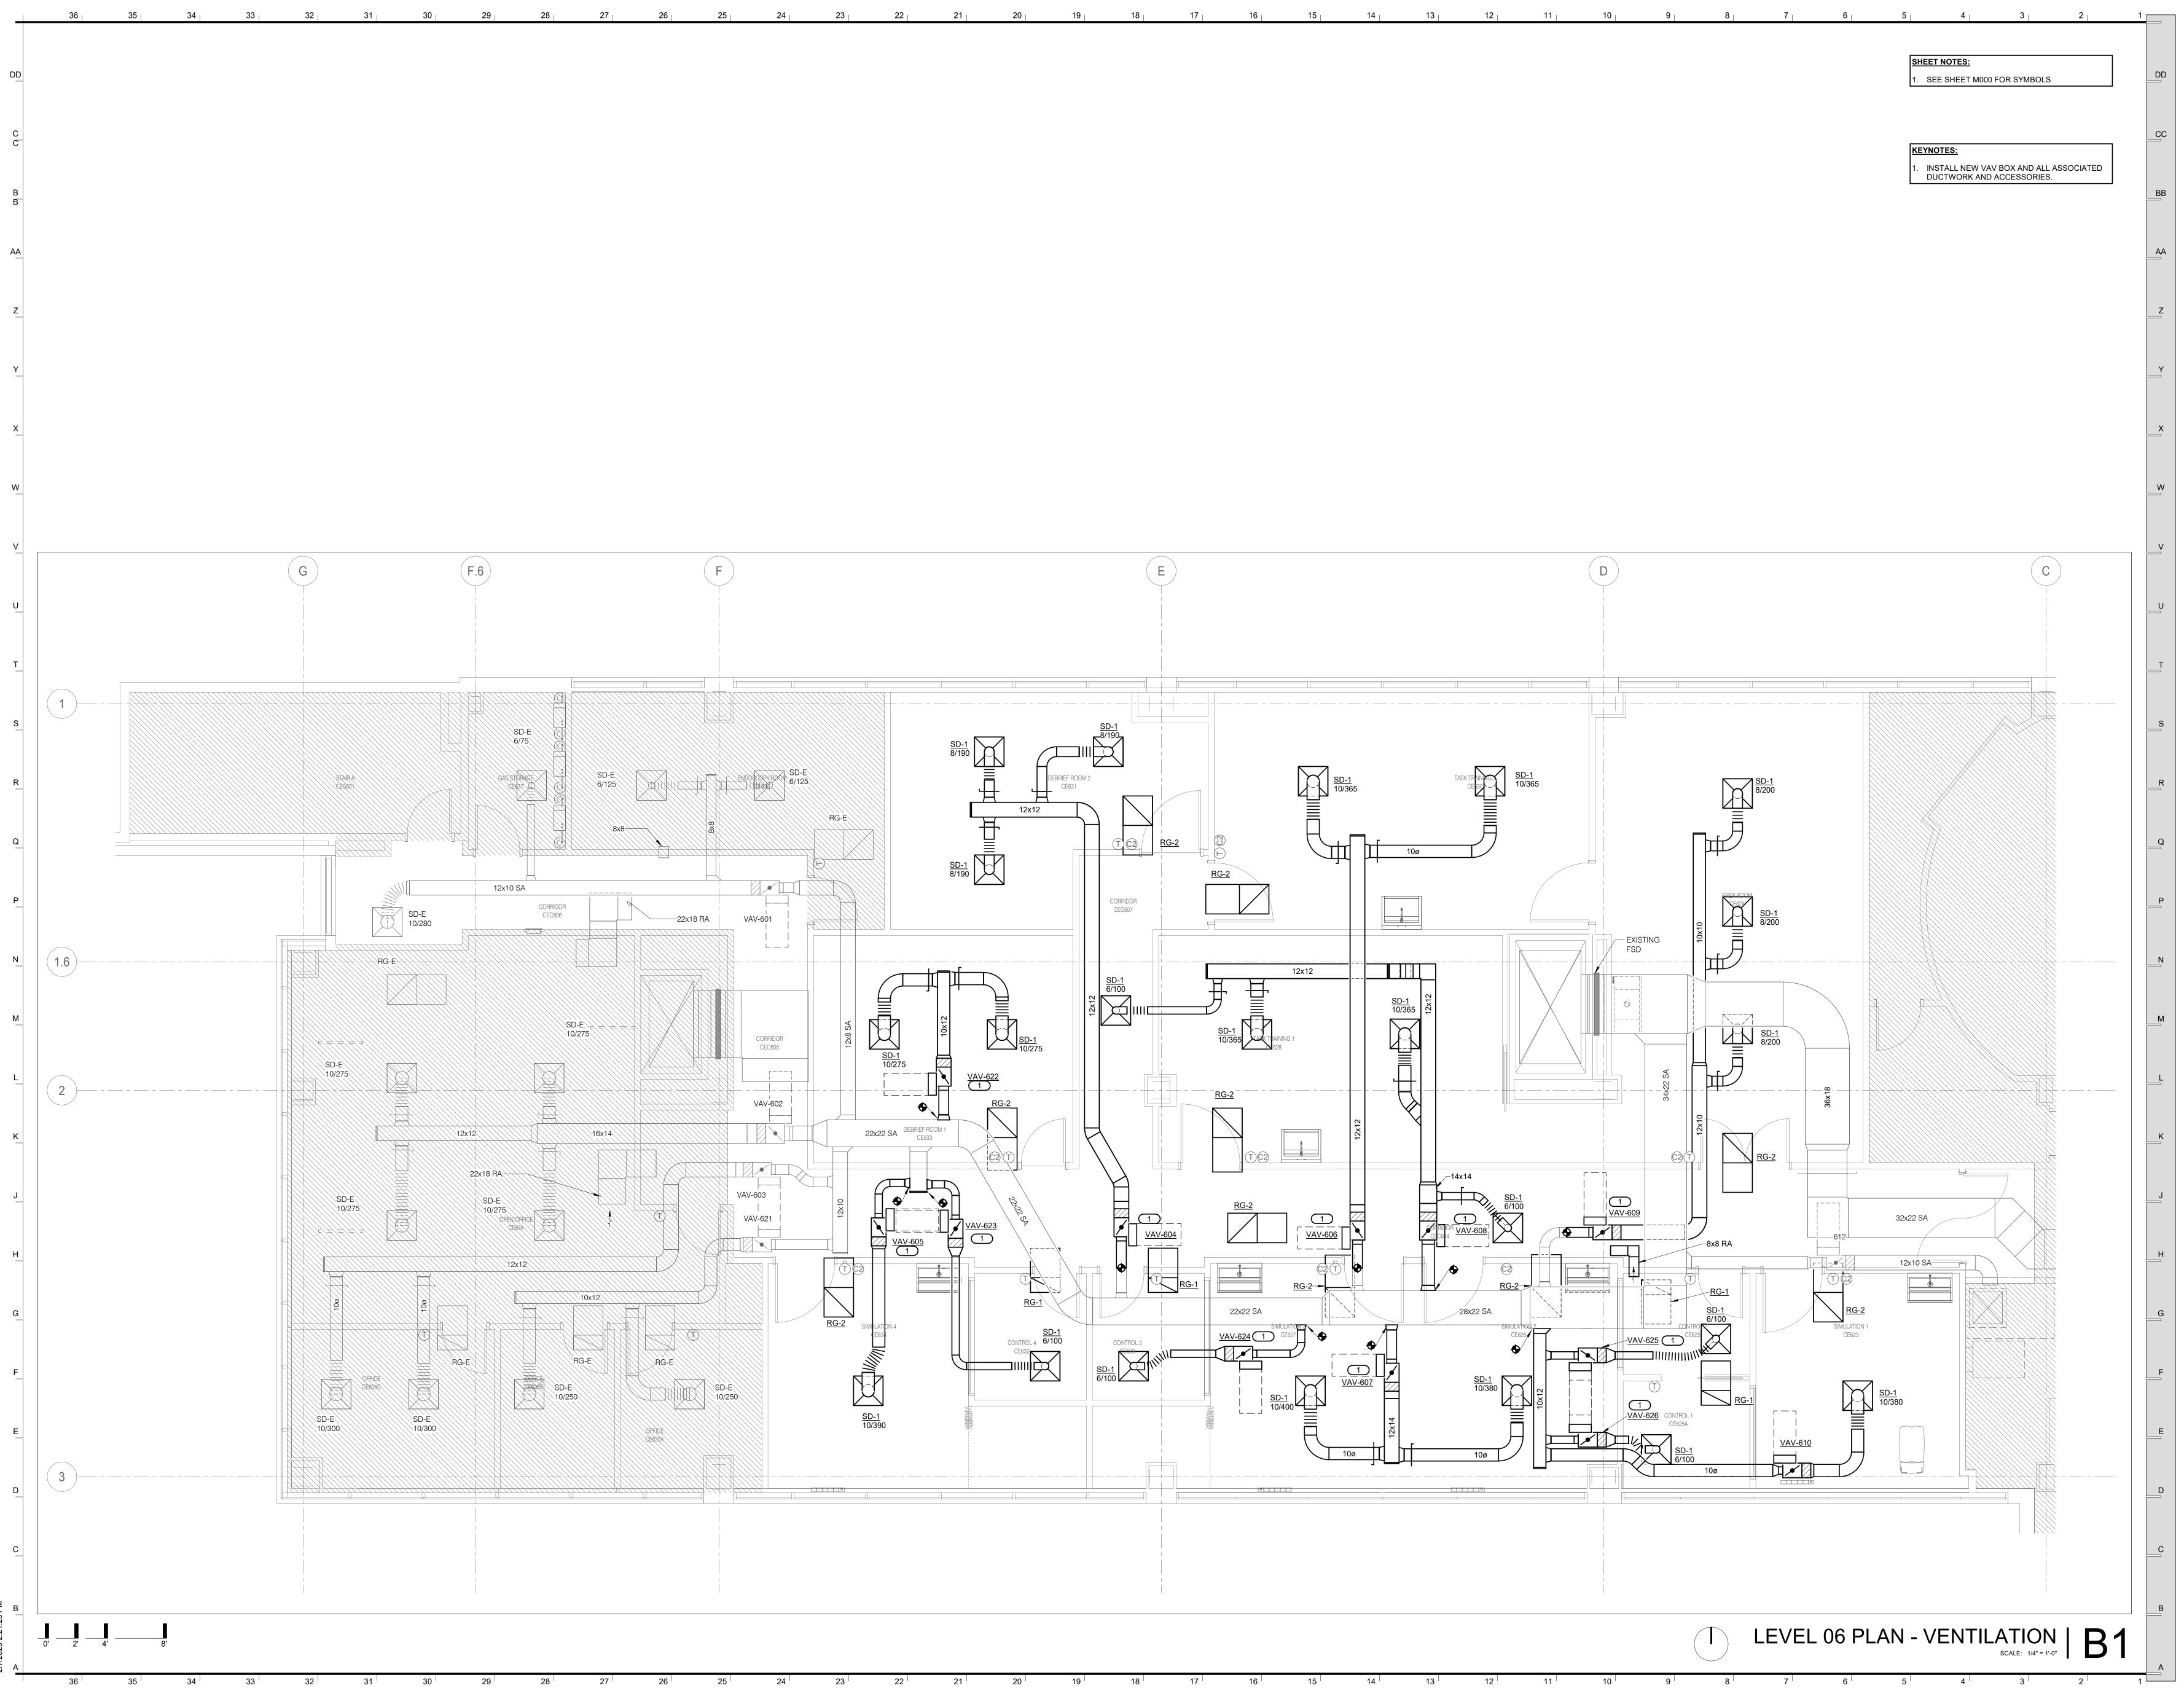
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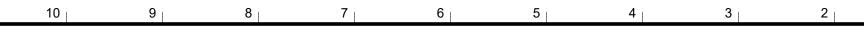
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02-21-2025 PHILLIP I. PARRA - ENGINEER MO#: E-28366

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SEAL:	
PHILIP	

DATE:	02/21/2025
PROJ. NO.:	CP250271
DESIGNED BY:	CSB
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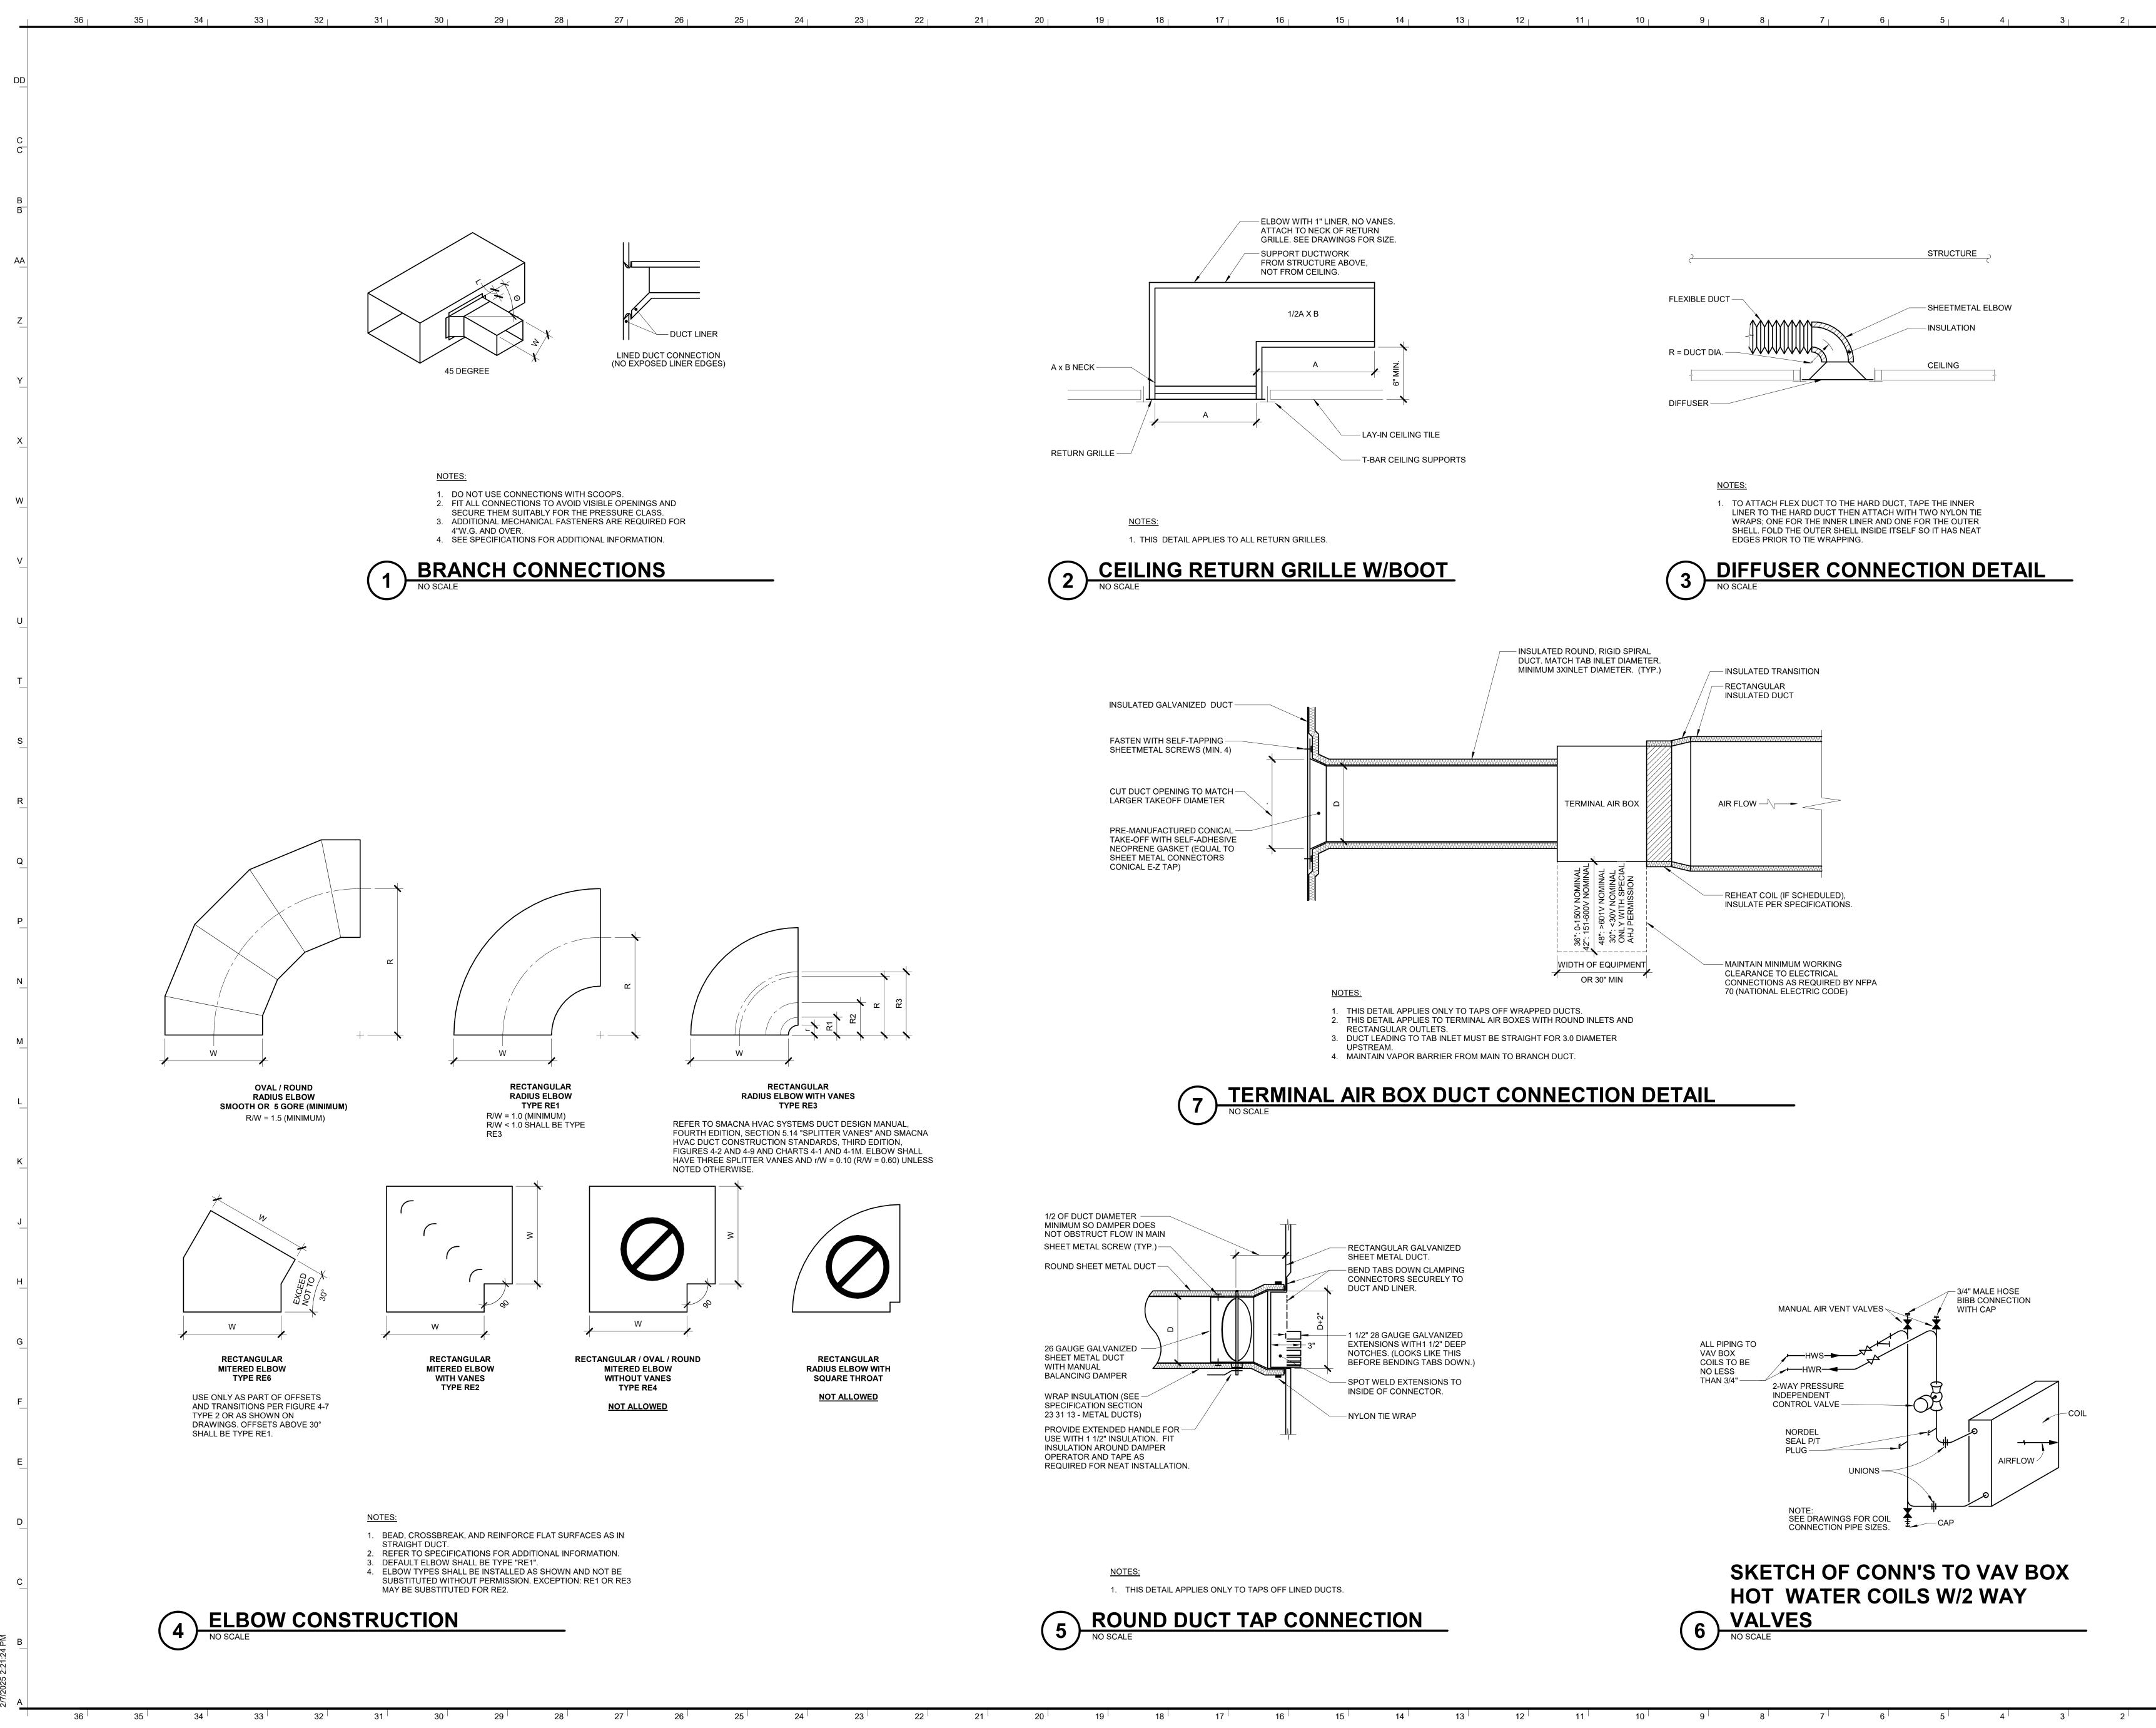
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HVAC DETAILS

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PHILLIP I. PARRA - ENGINEER

MO#: E-28366

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PHILLIP

I. PARRA NUMBER E-28366 450 H 460

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02/21/2025

CP250271

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02-21**-**2025

COLUMBIA, MO 65201

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OTES:													
				EVELS SHALL E. EAT COIL SHALL					C PRESSURE W	HEN TESTED PE	R AHRI STANDARD 885-2	2008 USING 5/8" 20-	-LB DENSITY MINERAL FIBER CEILING TILE.
				TION OF CONTR			50 WC.						
SENSOF	R TYPES: 1 - SI	ENSOR ONLY,	2 - SENSOR	WITH ADJUSTM	ENT, 3 -	SENSOF					IT AND OVERRIDE.		
								COILS SH	HALL NOT EXCE	ED 5'. PROVIDE F	REHEAT COILS SEPARAT	E FROM BOXES IF	REQUIRED TO MEET WATER PRESSURE DROP REQUIREMENTS. WH
				ATING COIL IS NO									
				VAV CONTROLS			I URE A		ABLE FLOW (GP	M). PROVIDE FIN	AL MAXIMUM FLOW RAI	E (GPM) TO TEST	& BALANCE TERMPERATURE CONTROLS CONTRACTORS.
000017						no box.							
		С	FM		HEA	FING CO	L (NOT	ES 5, 6)					
TAG	COOLING	HEATING	OCCUPIED	UNOCCUPIED			ÈWT	MAX.	MIN. INLET	SENSOR TYPE		MODEL	
NAME	MAX.	MAX.	MIN.	MIN.	EAT °F	LAT °F	°F	GPM	SIZE (IN.) DIA.	(NOTE 4)	MANUFACTURER	(NOTES 1, 2)	NOTES
/AV-604	570	570	570	205	55.0	95.0	180	1.2	8"	2	TITUS	DESV	NOTES 1, 2, 3, 7
/AV-605	390	390	390	120	55.0	95.0	180	0.8	6"	2	TITUS	DESV	NOTES 1, 2, 3, 7
/AV-606	730	730	730	220	55.0	95.0	180	1.6	8"	2	TITUS	DESV	NOTES 1, 2, 3, 7
/AV-607	780	780	780	235	55.0	95.0	180	1.7	8"	2	TITUS	DESV	NOTES 1, 2, 3, 7
/AV-608	930	930	930	280	55.0	95.0	180	2.0	10"	2	TITUS	DESV	NOTES 1, 2, 3, 7
/AV-609	600	330	330	180	55.0	95.0	180	0.7	8"	2	TITUS	DESV	NOTES 1, 2, 3, 7
/AV-610	380	380	380	75	55.0	95.0	180	0.8	6"	2	TITUS	DESV	NOTES 1, 2, 3, 7
/AV-622	550	550	550	165	55.0	95.0	180	1.2	8"	2	TITUS	DESV	NOTES 1, 2, 3, 7
	100	100	100	45	55.0	95.0	180	0.5	6"	2	TITUS	DESV	NOTES 1, 2, 3, 7
/AV-623	100	100	100	45	55.0	95.0	180	0.5	6"	2	TITUS	DESV	NOTES 1, 2, 3, 7
		100	100	45	55.0	95.0	180	0.5	6"	2	TITUS	DESV	NOTES 1, 2, 3, 7
VAV-623 VAV-624 VAV-625	100						180		6"	2	TITUS	DESV	NOTES 1, 2, 3, 7

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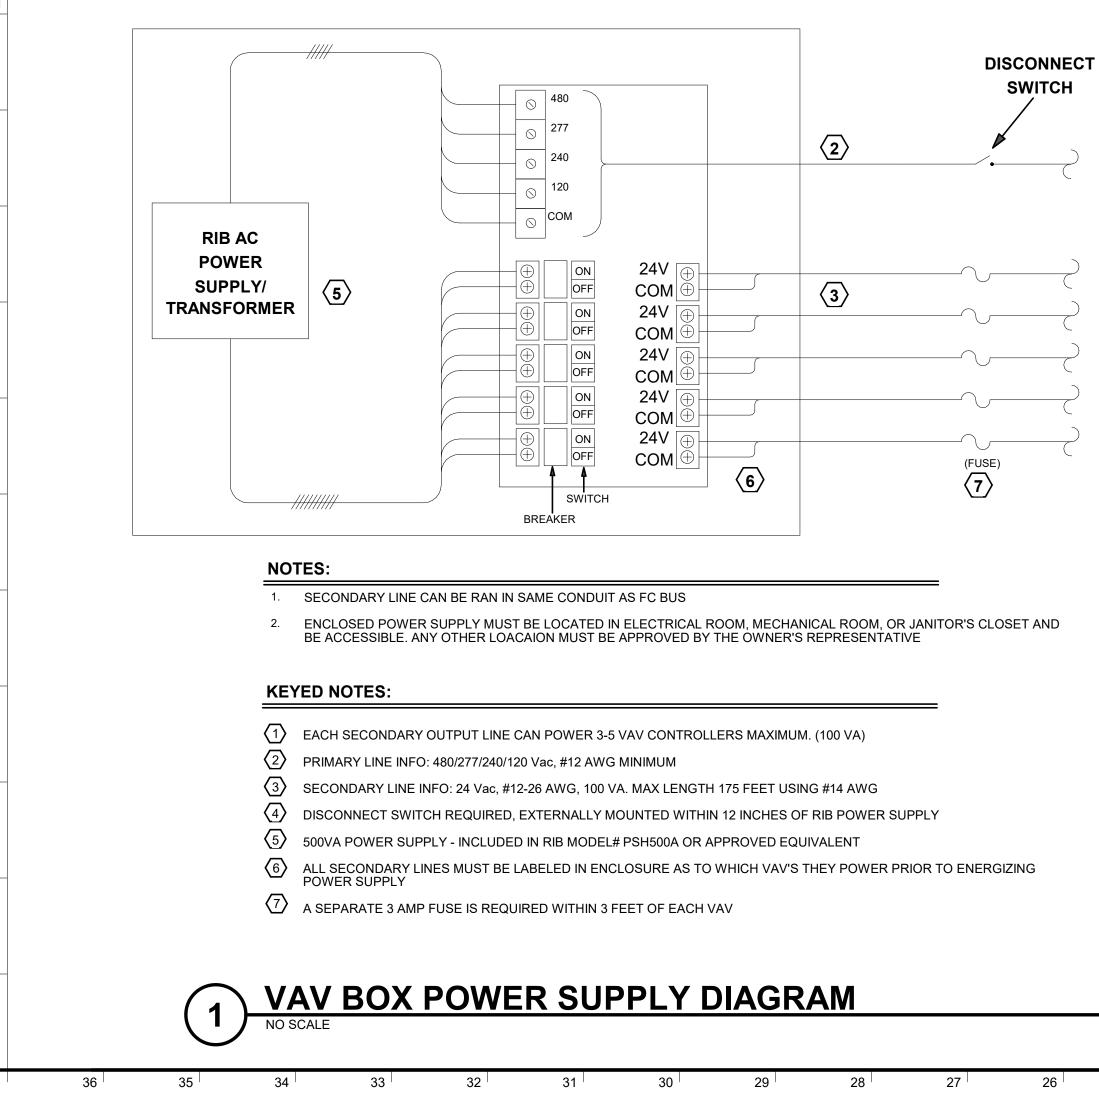
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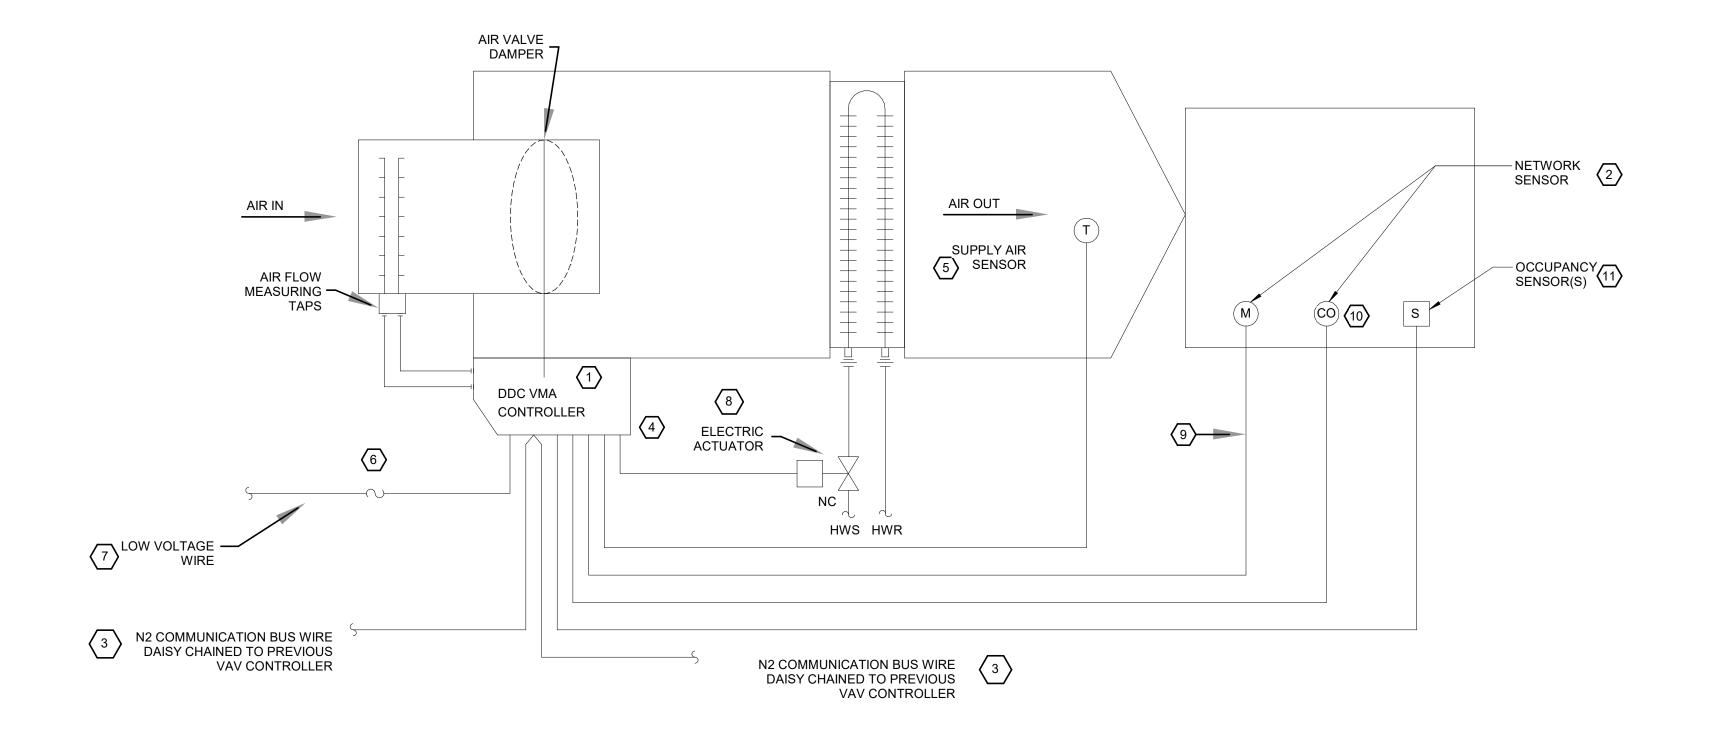
AIR TERMINAL SCHEDULE

INUTES:
1.CONTRACTOR SHALL DETERMINE PROPER BORDER TYPE TO MATCH CEILING CONSTRUCTION.
2.REFER TO DRAWINGS FOR NECK SIZE. ALL BRANCH DUCTWORK TO AIR TERMINALS SHALL BE NECK SIZE UNLESS NOTED OTHERWISE.

2.REFER TO DRAWINGS FOR NECK SIZE. ALL BRANCH DUCTWORK TO AIR TERMINALS SHALL BE NECK SIZE UNLESS NOTED OTHERWISE.									
TAG NAME	FACE SIZE (IN.) (NOTE 2)	ТҮРЕ	BORDER (NOTE 1)	MATERIAL	FINISH	MANUFACTURER	MODEL	NOTES	
SD-1	24x24	PANEL FACE	LAY-IN	STEEL	WHITE	TITUS	OMNI	FLUSH FACE PANEL	
RG-1	24x12	EGGCRATE GRILLE	LAY-IN	ALUMINUM	WHITE	TITUS	50F		
RG-2	24x24	EGGCRATE GRILLE	LAY-IN	ALUMINUM	WHITE	TITUS	50F		







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NOTES:

- 1. VMA TERMINAL INCLUDES CONSTANT VOLUME (CV) UNITS & VARIABLE AIR VOLUME (VAV) UNITS. UNLESS OTHERWISE
- 2. CAPS FOR VAV DP TEST PORTS MUST BE NEOPREME CAPS OR 1/4" BRASS PLUGS. NO RUBBER CAPS ALLOWED.


KEYED NOTES: (#)

- 1. CONTROLLER WILL BE FURNISHED BY OWNER. CONTROLLER WILL BE JCI MODEL M4-CVM03050. PROGRAMMING WILL BE PROVIDED BY OWNER.
- 2. NETWORK SENSOR WILL BE FURNISHED BY OWNER & INSTALLED BY CONTRACTOR.

NOTED, ALL CONTROL WORK SHALL BE BY CONTRACTOR.

- 3. N2 COMMUNICATION BUS WIRE SHALL BE 18 AWG, PLENUM RATED, TWISTED SHIELDED, WITH BLUE-BLACK-WHITE COLOR CODED 3 CONDUCTOR, WITH BLUE OUTER CASING, DESCRIPTED AS 18-03 OAS STR PLNM NEON BLU JK DISTRIBUTED BY WINDY CITY WIRE, CONSTRUCTED BY CABLE-TEK, OR APPROVED EQUIVALENT.
- 4. CONTROLLER MUST HAVE A MINIMUM OF 18 INCHES OF ACCESSIBLE CLEARANCE.
- 5. VAV SUPPLY TEMP SENSOR 1000 OHM PLATINUM RTD LOCATED APPROX. 8 FT. FROM VAV BOX DISCHARGE. PROVIDED, INSTALLED, & WIRED TO CONTROLLER BY CONTRACTOR.
- 6. FUSE LOCATED WITHIN 2 FT. OF VMA CONTROLLER, IN LINE REMOVABLE FUSE, NOT FIXED TO FUSE HOLDER.
- 7. LOW VOLTAGE WIRE BY DIVISION 23. SEE ELECTRICAL DRAWINGS FOR SOURCE.
- 8. VALVE WITH PROPORTIONAL 0-10 VOLT ACTUATOR OR EQUIVALENT.
- 9. SA BUS WIRE SHALL BE 22 AWG, PLENUM RATED, TWISTED SHIELDED, 4 CONDUCTOR.
- 10. CO2 SENSOR. SEE PLANS FOR LOCATIONS.
- 11. INSTALLATION OF OCC SENSOR IS WORK OF DIVISION 26, SEE E-SERIES SHEETS FOR FINAL LOCATIONS, A CONTROL CIRCUIT SHALL BE CONNECTED TO ALL OCC SENSORS AS WORK OF DIVISION 23. A CONTROL SIGNAL SHALL BE RELAYED TO THE VAV TERMINAL UNIT THAT SERVES THAT SPACE. IN LOCATIONS WHERE MULTIPLE OCC SENSORS ARE PRESENT, ALL SENSORS SHALL BE MONITORED AND TRANSMIT A SIGNAL TO THE VAV TERMINAL UNIT WITHIN THAT SPACE, ALL SENSORS SHALL BE WIRED IN PARALLEL. OCCUPANCY SENSOR WIRING MUST BE RAN BACK TO VAV CONTROLLER FOR OWNER TERMINATION. PRIOR TO CEILING GRID INSTALLATION. OCC SENSOR INSTALLATION AND TERMINATIONS BY CONTRACTOR.



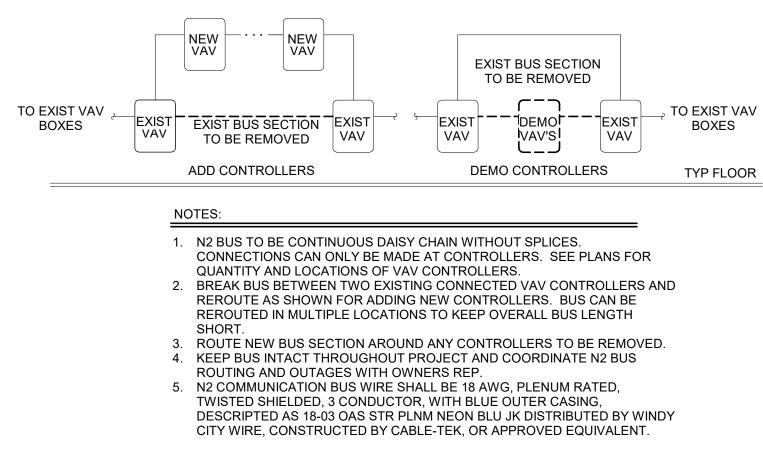

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N2 BUS DIAGRAM

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HVAC SCHEDULES

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PHILLIP I. PARRA - ENGINEER

MO#: E-28366

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CHECKED BY:	SGB
APPROVED BY:	SGB
SEAL:	

PHILLIP

I. PARRA

NUMBER E-28366

450 H 460

02/21/2025

CP250271

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02-21**-**2025

5 HOSPITAL DR. COLUMBIA, MO 65201

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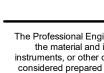


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VIEW KEY	ELECTRICAL SYMBOL LIST	ELECTRICAL SYMBOL LIST] [ELE	CTRICA	L SYMBOL LIST	ELECTRICAL RENOVATION NOTES
NAME - LEVEL NAME	TO SYMBOL: TAG: SPEC DESCRIPTION:	SYMBOL: SPEC SPEC DESCRIPTION:	SYMBOL:	TAG:	SPEC	DESCRIPTION	THESE NOTES APPLY TO ALL ELECTRICAL SHEETS AND TRADES, INCLUDING BUT TO, LIGHTING, POWER, FIRE ALARM, AND OTHER LOW VOLTAGE SYSTEMS.
TO'-0" - HEIGHT ABOVE PROJECT 0'-0" DESCRIBE ADDITIONAL INFOR ABOUT WORK REQUIRED, SPI		STMBOL: TAG: SECTION: S 26 09 33 SWITCH	COMMON AND		SECTION	SUBSCRIPTS: TYPE / PROGRAMMING	1. EXISTING CONDITIONS ARE SHOWN BASED ON INFORMATION OBTAINED FRO SURVEYS, EXISTING BUILDING DOCUMENTS. CONTRACTOR SHALL REVIEW EX
TO THE SHEET AND/OR DETA	E ECONN 26 05 33 ELECTRICAL CONNECTION	## SUBSCRIPTS: <u>SW-1P</u> BLANK = SINGLE POLE <u>SW-3W</u> 3 = THREE WAY	SEQUENCE OF OPERATION SUBSCRIPTS			WG = WIRE GUARD IS REQUIRED W = WEATHERPROOF	CONDITIONS AND REPORT CONFLICTS. 2. NOT ALL EXISTING EQUIPMENT, LUMINAIRES, AND CONDUIT ARE SHOWN. CO SHALL REVIEW EXISTING CONDITIONS AND REPORT CONFLICTS.
INDICATES DIRECTION OF TRUE NORTH	JB 26 05 33 JUNCTION BOX	SW-SW 3 = THREE WAY SW-4W 4 = FOUR WAY SW-D D = DIMMER - STAND ALONE				A = ATRIUM CA = CLEAN AGENT SYSTEM	 CONTRACTOR SHALL REVIEW EXISTING CONDITIONS AND REPORT CONFLICTS. CONTRACTOR SHALL REVIEW EXISTING CONDITIONS PRIOR TO FABRICATION TRAY, BUSWAY, CONDUIT RACKS, AND OTHER SYSTEMS. RISES AND DROPS I
PLAN OR DETAIL NAME		SW-D3 D3=DIMMER - THREE WAY WITH S3 TYPE SW-DML DML=DIMMER - MULTI-LOCATION FADE				CR = COMPUTER ROOM E = ELEVATOR RECALL	NECESSARY BECAUSE OF EXISTING FIELD CONDITIONS. 4. ELECTRICAL CONTRACTOR SHALL REVIEW EXISTING CONDITIONS TO VERIFY
	EB-# or PT-# 26 27 26 FLOOR BOX or POKE THROUGH	CONTROL [NTS: RESIDENTIAL USE - DIFFERS FROM #B PUSH BUTTON DIMMER] SW-DO DO=DIMMER - OCCUPANCY/VACANCY				D = HVAC CONTROL DH = DOOR HOLD RELEASE DIPS = DUAL INTERLOCK PREACTION SYS	TO THE AREAS OF THEIR WORK INCLUDING WALLS, FLOOR, CEILINGS, CEILIN AND ROOF. ELECTRICAL CONTRACTOR IS RESPONSIBLE TO PROVIDE CUTTIN PATCHING, AND REINSTALLATION OF AFFECTED AREAS ASSOCIATED WITH TI
1/8" = 1'-0"	RI C# <u>RI-TECH</u> 26 05 33 TECHNOLOGY OUTLET ROUGH-IN # INDICATES # OF OWNED PROVIDED CARLES	SENSORS - DUAL TECHNOLOGY ULTRASONIC/ACOUSTIC AND PIR				FD = FIRE DOOR RELEASE MP = MEDICAL PROCEDURE	COORDINATING WITH THE GENERAL CONTRACTOR OR QUALIFIED CONTRACT CONTRACTOR SHALL NOTIFY THE PRIME CONTRACTOR OF AFFECTED AREAS
PLAN OR DETAIL SCALE	# - INDICATES # OF OWNER PROVIDED CABLES E.C. SHALL PULL TO DEVICE	<u>SW-O</u> O = DUAL TECHNOLOGY OCCUPANCY SENSOR WITH WALL SWITCH				S = SLEEPING / PATIENT ROOM SW = STAIRWELL	BIDDING. 5. WHERE EXISTING ELECTRICAL SYSTEMS ARE LOCATED IN AREAS THAT CONF
INDICATES SIMILAR DETAIL REFERENCED	R1 RI-TECH-CR 26 05 33 CARD ACCESS READER (WALL), ROUGH-IN W/RI V/RI 26 05 33 TECHNOLOGY ROUGH-IN, WALL PHONE	SW-1P-K SW-1P-PLK = SINGLE POLE - KEY LOCK P = SINGLE POLE - RED PILOT LIGHT				# = 15, 30, 75, 110, 177 CANDELA RATING CD = CANDELA RATING SELECTED BY NICET DESIGNER	EQUIPMENT, PIPING, OR DUCTWORK TO BE INSTALLED, EACH CONTRACTOR ARRANGE NEW EQUIPMENT, CONDUIT, OR DUCTWORK IN SUCH A FASHION T NOT CONFLICT WITH EXISTING SYSTEMS, OR REWORK EXISTING ELECTRICAL
SIM IN MULTIPLE LOCATIONS SIM	Image: Second	LS <u>SW-LS</u> 26 09 33 DAYLIGHT LEVEL SENSOR - CEILING MOUNTED SUBSCRIPTS:					ALLOW FOR INSTALLATION OF NEW EQUIPMENT, PIPING, OR DUCTWORK.
M101 - SHEET DETAIL IS LOCATED ON - T101 - 3	TV RI-TV 26 05 33 TV ANTENNA OUTLET ROUGH-IN	## BLANK = DIMMING CONTROL # = SPECIAL FUNCTION S = SWITCHED CONTROL		<u>FACP-#</u> <u>NAC-#</u>	28 31 00 28 31 00	FIRE ALARM CONTROL PANEL NOTIFICATION APPLIANCE CIRCUIT	ELECTRICAL INSTALLATION NOTE
	<u>WM-#</u> 26 05 35 MULTI OUTLET SYSTEM	W =WIRELESS WITH BATTERY			28 31 00	PANEL FIRE ALARM SMOKE DETECTOR.	1. THE COMPLETE INSTALLATION SHALL BE IN ACCORDANCE WITH THE ADA ST
LINE TYPE AND TAG KEY: NEW WORK BY THIS CONTRACTOR (WIDE LINE)	EPO26 09 16EMERGENCY STOP / POWER OFF26 32 13(N.C. AND N.O CONTACT)	26 09 33 OCCUPANCY SENSOR - CEILING MOUNTED ## OUV OD F		<u>FA-120</u>	28 31 00	CEILING OR WALL MOUNT	ACCESSIBLE DESIGN. REFER TO THE ADA GUIDELINES FOR ALL CONFIGURAT THIS PAGE FOR ADDITIONAL INFORMATION.
NEW NORK BY THIS CONTRACTOR (WIDE LINE) ————————————————————————————————————	ES ES 26 09 16 EMERGENCY STOP, N.C. CONTACT	## SW-OC-D BLANK = DUAL TECHNOLOGY SW-OC-A A = ULTRASONIC - TWO SIDED CORRIDOR				BLANK - PHOTOELECTRIC CO = COMBINATION SMOKE / CARBON	 CIRCUIT NUMBERS ARE SHOWN FOR CIRCUIT IDENTIFICATION. CIRCUITING S WITH NUMBERING ON THE PANEL PROVIDED. COMMON NEUTRALS MAY NOT BRANCH CIRCUITS. BALANCE THE LOAD ON PANEL AS EVENLY AS POSSIBLE
	PB PB 26 09 16 MOMENTARY PUSHBUTTON OPERATOR D PANEL '###' 26 24 16 PANELBOARD - RECESS MOUNT	SW-OC-P COVERAGE SW-OC-P2 P = PASSIVE INFRARED - 360° COVERAGE SW-OC-U P2=PASSIVE INFRARED - 100° COVERAGE U = ULTRASONIC - 360° COVERAGE	Ц			MONOXIDE ID = IN DUCT DETECTOR	9. EMERGENCY BRANCH WIRING FOR FEEDERS AND BRANCH CIRCUITS SHALL
EXISTING TO REMAIN OR WORK BY OTHERS (NARROW LINE) ———————————————————————————————————	PANEL '###' 26 24 16 PANELBOARD - RECESS MOUNT PANEL '###' 26 24 16 PANELBOARD - SURFACE MOUNT	SW-OC-U U = ULTRASONIC - 360° COVERAGE VC 26 09 33 VACANCY SENSOR - CEILING MOUNTED	\$	<u>FA-122</u>	28 31 00		SEPARATE RACEWAY, JUNCTION BOXES, PULL BOXES, AND CABINETS. WIRIN BRANCH SHALL BE INDEPENDENT FROM OTHER BRANCHES, INCLUDING THE
EXISTING TO BE REMOVED BY OTHERS (SHORT DASHED PATTERN)	MX-#/MS-# 26 24 19 SURFACE OR RECESS MOUNTED MANUAL	## <u>SW-VC-D</u> SW-VC-A ACANCT SENSOR - CEILING MOONTED SUBSCRIPTS: BLANK = DUAL TECHNOLOGY A = ULTRASONIC - TWO SIDED CORRIDOR		<u>FA-130</u>	28 31 00	# = EQUIP OR SYSTEM FIRE ALARM MANUAL PULL STATION	BRANCH. 4. FLUSH MOUNT ALL LIGHTING CONTROL DEVICES AT +42" FROM FLOOR (CENT
HALFTONING DOES NOT MODIFY SCOPE.	CIRCUIT BREAKER. MANUAL DISCONNECT /	COVERAGE		FA-131	28 31 00	FIRE ALARM MANUAL PULL STATION W/ COVER	DIMENSION), EXCEPT WHERE OTHERWISE NOTED. 5. FLUSH MOUNT ALL DUPLEX RECEPTACLES AND TECHNOLOGY OUTLETS AT + FLOOR (CENTERLINE DIMENSION), EXCEPT WHERE OTHERWISE NOTED. REC
'TAG'-E TAGS WITH DASH 'E' INDICATES THE REFERENCED OBJECT IS EXISTING	/AS-#/SS-#/ FUSED SWITCH (PLUG FUSE) / AUTOMATIC MCS-#/ STARTER / SOLID STATE - SOFT STARTER / AMS-# COMBINATION STARTER / MOTOR CIRCUIT	SW-VC-P SW-VC-P2P = PASSIVE INFRARED - 360° COVERAGESW-VC-P2 SW-VC-UP2=PASSIVE INFRARED - 100° COVERAGEU = ULTRASONIC - 360° COVERAGE		FA-200	28 31 00	FIRE ALARM VISUAL ALARM DEVICE, CEILING	OUTLETS MAY BE SURFACE MOUNTED WHEN CONDUIT IS SPECIFIED EXPOSE EXTERIOR LOCATED RECEPTACLES WITH WHILE-IN-USE COVERS AT +20" FRO
TAG-1 UNDERLINED TAG INDICATES OBJECT IS IN-SCOPE. IF NEW, ADDITIONAL INFORMATION IS AVAILABLE IN A SCHEDULE, MATERIAL LIST, OR SYMBO		OC 26 09 33 OCCUPANCY SENSOR - WALL MOUNTED				OR WALL MOUNT # = CANDELA RATING.	GRADE (CENTER DIMENSIONS) TO MAINTAIN INSTALLATION ADA COMPLIANCE 6. ALL MATERIALS USED TO SEAL PENETRATIONS OF FIRE RATED WALLS AND F
INDICATES AN EXISTING SYSTEM'S POINT OF CONNECTION/REMOVAL	TR-#/DTR-# 26 22 00 TRANSFORMER. REFER TO TRANSFORMER SCHEDULE	## SUBSCRIPTS: SW-OC-D BLANK = DUAL TECHNOLOGY SW-OC-A A = ULTRASONIC - TWO SIDED CORRIDOR				CD = CANDELA RATING. CD = CANDELA RATING SELECTED BY NICET DESIGNER	BE TESTED AND CERTIFIED AS A SYSTEM PER ASTM E814 STANDARDS FOR F THROUGH-PENETRATION FIRESTOPS. REFER TO DIVISION 7 FOR ADDITIONAL AND REQUIREMENTS SPECIFIC TO FIRESTOPPING.
	DS-#/FDS-#/DSS-# 26 28 16 DISCONNECT SWITCH	COVERAGE		<u>FA-210</u>	28 31 00	AUDIO HORN/CHIME ALARM DEVICE, CEILING OR WALL MOUNTED	 CONNECTION FOR ELECTRIC WATER COOLERS (EWC) SHALL BE A JUNCTION CONCEALED BEHIND WATER COOLER ACCESS PLATE OR BE A GFI RECEPTAGE
CONTRACTOR ABBREVIATION KEY	FUSED DISCONNECT SWITCH INTERLOCKED RECEPTACLE DISCONNECT.	SW-OC-P SW-OC-P2 SW-OC-UP = PASSIVE INFRARED - 360° COVERAGE P2=PASSIVE INFRARED - 100° COVERAGE U = ULTRASONIC - 360° COVERAGE	# #			M = MINI-HORN	DIRECTLY BELOW AND CENTERED ON EWC. CONTRACTOR SHALL VERIFY TY BE INSTALLED.
ABBR: DESCRIPTION:	DB DB ARCH DOOR BELL	VC 26 09 33 VACANCY SENSOR - WALL MOUNTED ## SUBSCRIPTS:				S = SLEEPING / PATIENT ROOM	 MOUNT ALL FIRE ALARM PULL STATIONS AT +42" FROM FLOOR (CENTERLINE EXCEPT WHERE OTHERWISE NOTED. INSTALL ALL WALL MOUNTED FIRE ALARM NOTIFICATION DEVICES AT 90" ABC
C.M. CONSTRUCTION MANAGER	HD HD ARCH HAND DRYER	SW-VC-D BLANK = DUAL TECHNOLOGY SW-VC-A A = ULTRASONIC - TWO SIDED CORRIDOR COVERAGE		<u>FA-211</u>	28 31 00	COMBINATION AUDIO HORN/CHIME AND VISUAL ALARM DEVICE, CEILING OR WALL	9. INSTALL ALL WALL MOUNTED FIRE ALARM NOTIFICATION DEVICES AT 90 AD FLOOR OR 6" BELOW THE CEILING, WHICHEVER IS LOWER, EXCEPT WHERE (NOTED. HEIGHT SHALL BE MEASURED TO THE TOP OF THE DEVICE.
E.C. ELECTRICAL CONTRACTOR F.P.C. FIRE PROTECTION CONTRACTOR	PP PP ARCH PUSH PAD	SW-VC-PP = PASSIVE INFRARED - 360° COVERAGESW-VC-P2P2=PASSIVE INFRARED - 100° COVERAGE				MOUNTED # = CANDELA RATING	10. CONTRACTOR SHALL COORDINATE THE LOCATION OF ALL CEILING MOUNTED EQUIPMENT WITH LUMINAIRES, SPRINKLER, AND CEILING DIFFUSERS. CENTE
G.C. GENERAL CONTRACTOR		<u>SW-VC-U</u> U = ULTRASONIC - 360° COVERAGE				CD = CANDELA RATING CD = CANDELA RATING SELECTED BY NICET DESIGNER	IN CEILING TILE PATTERN. SMOKE DETECTORS, CARBON MONOXIDE DETECT OCCUPANCY/VACANCY SENSORS SHALL BE LOCATED NO CLOSER THAN 3 F
M.C. MECHANICAL CONTRACTOR P.C. PLUMBING CONTRACTOR		## SUBSCRIPTS: BLANK = STAND ALONE DEVICE	RT	<u>FA-242</u>	28 31 00	FIRE ALARM REMOTE INDICATOR W/ TEST SWITCH	SUPPLY DIFFUSER OR RETURN GRILLE. CARBON MONOXIDE DETECTORS SH 10 PLUS FT FROM FIRE PLACES, COOKING, AND SIMILAR FUEL-BURNING APP 11. CONTRACTOR SHALL VERIFY ALL FURNITURE. MODULAR FURNITURE, AND E
T.C.C. TEMPERATURE CONTROLS CONTRACTOR	SYMBOL: TAG: SPEC SECTION: DESCRIPTION:	#BSW-#B26 09 33#R=ROOM BASED LIGHTING CONTROL DEVICE	FS	<u>FA-260</u>	28 31 00	FIRE ALARM FLOW SWITCH TO MONITOR SPRINKLER SYSTEM	LOCATIONS WITH ARCHITECTURAL PLANS, ELEVATIONS, AND REVIEWED SHO PRIOR TO MAKING THE ACTUAL ELECTRICAL INSTALLATION, THIS CONTRACT
	Image: matrix intermediate REC-DUP 26 27 26 DUPLEX RECEPTACLE, 125V	## MANAGEMENT CONTROL STATION KEYPAD WITH PROGRAMMABLE FUNCTION				BLANK = REFER TO PLANS	ADJUST RECEPTACLES, OUTLETS, OR CONNECTION LOCATIONS TO ACCOMI FURNITURE AND/OR EQUIPMENT.
EQUIPMENT ABBREVIATION KEY	Image: Marceneous constraints REC-DUP-GFI 26 27 26 DUPLEX GFI RECEPTACLE, 125V Image: Good Constraints REC-DUP-GFI-R 26 27 26 GROUND FAULT DEVICE	BUTTONS. # INDICATES NUMBER OF CONTROL ZONES	TS	<u>FA-261</u>	28 31 00	FIRE ALARM TAMPER SWITCH TO	12. ELECTRICAL AND TECHNOLOGY EQUIPMENT SHALL BE MOUNTED TO AVOID I OPERATION OF, AND/OR ACCESS TO ELECTRICAL AND MECHANICAL EQUIPM MOUNTING OF ELECTRICAL AND TELECOMMUNICATIONS EQUIPMENT, ON EQ
ABBR: DESCRIPTION:	$\frac{1}{100} \frac{1}{100} \frac{1}$	## INDICATES TYPE: SX: BUTTON PAD - X NUMBER OF BUTTONS				MONITOR SPRINKLER SYSTEM BLANK = REFER TO PLANS	SUPPLIED BY ANOTHER CONTRACTOR, SHALL BE APPROVED IN ADVANCE B' CONTRACTOR.
AD AUTOMATIC DOOR OPERATOR WITH SENSOR	$\Rightarrow_{U} \qquad \underline{\text{REC-USB}} \qquad 26\ 27\ 26 \qquad \text{DUPLEX RECEPTACLE, USB CHARGING}$	BLANK: 1 BUTTON DX: DIMMING ROCKER SWITCH - X NUMBER				PIV = POST INDICATOR VALVE	13. CONTRACTOR SHALL BE RESPONSIBLE FOR ALL OPENINGS REQUIRED IN WA OPENINGS SHALL BE REPAIRED TO MATCH EXISTING BY A QUALIFIED CONTR
COF COFFEE	→ REC-SIM-520R 26 27 26 SIMPLEX RECEPTACLE, 125V → REC-SIM-530R 26 27 26 RECEPTACLE, 125V	ALCR ALCR20 26 09 33 AUTOMATIC LOAD CONTROL RELAY - 20A -	MM	<u>FA-160</u>	28 31 00	FIRE ALARM ADDRESSABLE MONITOR MODULE	EXPENSE OF THIS CONTRACTOR. ALL CONDUITS THROUGH WALLS SHALL B SEALED INTO OPENINGS. 14. EACH CONTRACTOR IS RESPONSIBLE FOR DAMAGE CAUSED BY THEIR ACTION
COPY COPIER DB DOOR BELL	Image: Second control of the	TC SW-TC 26 09 33 TIME CLOCK SWITCH				BLANK = REFER TO PLANS KB = KNOX BOX MONITOR	WALLS, FLOORS, CEILINGS, AND ROOFS. THE CONTRACTOR WHOSE WORK (IS RESPONSIBLE FOR PATCHING TO MATCH ORIGINAL CONSTRUCTION, FIRE
DISP GARBAGE DISPOSAL	Image: Head State Rec-SIM-620R 26 27 26 RECEPTACLE, 6-20R, 250V			<u>FA-161</u>	28 31 00	FIRE ALARM ADDRESSABLE	FINISH. 15. REFER TO ARCHITECTURAL REFLECTED CEILING PLAN, ELECTRICAL, TECHN
DOOR DOOR OPERATOR, ELECTRIC DW DISHWASHER	Image: Head Stress REC-SIM-630R 26 27 26 RECEPTACLE, 6-30R, 250V Image: Head Stress REC-SIM-650R 26 27 26 RECEPTACLE, 6-50R, 250V	LIGHTING SYSTEM DESCRIPTION KEY:					AUDIO/VISUAL, AND OTHER ELECTRICAL PLANS FOR EXACT LOCATIONS OF A MOUNTED DEVICES, OTHER THAN SPRINKLERS. 16. ELECTRICAL IDENTIFICATION. REFER TO SPECIFICATION SECTION 26 05 53 F0
EPT ELECTRONIC PAPER TOWEL DISPENSER (NON-BATTERY)		THE DESIGN DOCUMENTS DESCRIBE THE OPERATIONAL PERFORMANCE REQUIREMENTS OF THE LIGHTING CONTROL SYSTEM. THE PROJECT MAY REQUIRE ONE OR MORE LIGHTING CONTROL				BLANK = REFER TO PLANS LC = LIGHTING CONTROL OVERRIDE	REQUIREMENTS FOR CONDUIT, BOX, CABLE/WIRE, AND EQUIPMENT.
ESP ESPRESSO MACHINE	-⊕I REC-SIM-L530R 26 27 26 RECEPTACLE, LOCKING TYPE, L5-30R, 125V	STRATEGIES FOR THE PROJECT. REFER TO THE ELECTRICAL SYMBOL KEY, SPECIFICATION SECTION 26 09 33 LIGHTING CONTROL SYSTEMS, AND THE DRAWINGS TO DETERMINE THE DESIGN APPLICATION FOR EACH SPACE. THE POTENTIAL STRATEGIES ARE AS FOLLOWS:				DH = DOOR HOLD OPEN PD = HOLD OPEN OVERRIDE	
EWC ELECTRIC WATER COOLER FAN CEILING FAN	Image: Head Structure REC-SIM-L620R 26 27 26 RECEPTACLE, LOCKING L6-20R, 250V Image: Head Structure REC-SIM-L630R 26 27 26 RECEPTACLE, LOCKING L6-30R, 250V	1. <u>STANDALONE LIGHTING CONTROL DEVICES</u> : INDEPENDENT (STANDALONE) DEVICES TRADITIONALLY OPERATING AT LINE OR LOW VOLTAGE, FIELD CONFIGURABLE WITH	DH	<u>FA-270</u>	28 31 00	FIRE ALARM DOOR HOLD DEVICE	
FDO FIRE DOOR OPERATOR	REC-TAMP 26 27 26 DUPLEX RECEPTACLE, TAMPER RESISTANT, 125V	TRADITIONALLY OPERATING AT LINE OR LOW VOLTAGE, FIELD CONFIGURABLE WITH OTHER STANDALONE DEVICES TO PROVIDE AN OVERALL LIGHTING CONTROL SYSTEM.	FSD	<u>FA-250</u>	28 31 00	(BY E.C.) FIRE ALARM SMOKE OR	
FFE OWNER FURNISHED FIXTURES, FURNITURE, AND EQUIPMENT FURN OWNER FURNITURE	Image: Weight of the sector with the sector w	2. <u>ROOM BASED LIGHTING CONTROLS</u> : INTEGRATED SYSTEM COMPRISED OF SWITCH STATIONS, SENSORS, ROOM CONTROLLERS, CONTROL PANELS, AND ACCESSORIES,				FIRE/SMOKE DAMPER CONTROL WITH DETECTOR, AND ADDRESSABLE MODULE, AND	
HD HAND DRYER	Image: matrix and second se	OPERATING AT LINE AND/OR LOW VOLTAGE, CONFIGURED AS AN INTEGRATED OVERALL 'INTELLIGENT' LIGHTING CONTROL SYSTEM. LIGHTING CONTROL ZONES AND POWER				REMOTE INDICATOR (WITH TEST SWITCH WHEN APPLICABLE)	
ICE ICE MACHINE MS MOTORIZED SHADE	➡ REC-QUAD 26 27 26 QUAD RECEPTACLE, 125V ➡ REC-QUAD-GFI 26 27 26 QUAD GFI RECEPTACLE, 125V	CIRCUITS COMMONLY ALIGN.				# = INDICATES EQUIP OR SYSTEM	
MW MICROWAVE	U REC-QUAD-USB 26 27 26 QUAD RECEPTACLE, USB 125V	LIGHTING CONTROL SYSTEM DESIGNATION: THE FOLLOWING KEY MAY BE USED AS AN EXAMPLE TO DETERMINE THE DESIGNATED LIGHTING CONTROL SYSTEM FOR EACH SPACE. REFER TO ELECTRICAL COVERSHEET FOR ELECTRICAL SYMBOLS LIST AND DEVICE SPECIFICATION					
OHD OVERHEAD DOOR		TAG. REFER TO THE SPECIFICATIONS FOR ADDITIONAL INFORMATION.		LUM	NAIRE	SHADING KEY	
PP PUSH PAD AUTOMATIC DOOR OPERATOR (REFER TO ARCHITECTURAL PLANS FOR FINAL LOCATION)	ELECTRICAL EQUIPMENT TAGS	1. <u>STANDALONE LIGHTING CONTROL DEVICES</u> : CONTROL STATION COMMONLY DEFINED BY AN ALPHA CHARACTER WITH SUBSCRIPTS.	│	NORMAL BRA	ANCH LUMINAI	IRE	
REF REFRIGERATOR	TAG: DESCRIPTION: RELATED SPECIFICATION SPECIFICATION	A. EXAMPLE SYMBOL "S", SPECIFICATION TAG "SW-1P", DESCRIPTION "SWITCH- SINGLE POLE SWITCH".		EMERGENC	BRANCH LUN	/INAIRE	
SINK SCRUB SINK STOVE RANGE / OVEN APPLIANCE	ATS-# AUTOMATIC TRANSFER SWITCH, REFER TO 26 36 00 TRANSFER SWITCH SCHEDULE 26 36 00	 B. EXAMPLE CONTROL DESIGNATION: a, b, c (WHEN REQUIRED TO CLARIFY DESIGN INTENT). 					
TCP TEMPERATURE CONTROLS PANEL	C-# GENERAL PURPOSE CONTACTOR 26 28 21 CR-# CORD REEL 26 27 26	C. SINGLE POLE LIGHT SWITCH "SA" CONTROLS LUMINAIRES WITH THE SUBSCRIPT "a" WITHIN THE SAME SPACE.	SHADED LUMINA EMERGENCY CI		CE INDICATES	LUMINAIRE OR DEVICE IS CONNECTED TO AN	
TV TELEVISION - MONITOR - DISPLAY UCF UNDERCOUNTER FREEZER	CT-# CABLE TRAY 26 05 36	D. REFER TO THE LIGHT CONTROL SEQUENCE OF OPERATION TAG {L#-##} FOR A COMPLETE DESCRIPTION OF THE LIGHTING CONTROL REQUIREMENTS.					
UCM UNDERCOUNTER MICROWAVE	DP-#DISTRIBUTION PANEL26 24 16DTR-#TRANSFORMER - DISTRIBUTION TYPE26 12 19OTR-#TRANSFORMER - DISTRIBUTION TYPE26 12 13	F# a	LUMI	NAIRE	CIRCUI	T AND CONTROL KEY	
	REFER TO TRANSFORMER SCHEDULE 26 12 13 26 12 16 26 12 21		<u><u>F1</u> =</u>	= FIXTURE TAG			
VEND VENDING MACHINE	<u>GEN-#</u> GENERATOR 26 32 13	2. ROOM BASED LIGHTING CONTROLS: CONTROL STATION COMMONLY DEFINED BY A		SWITCH DESIGN	GNATION		
ELECTRICAL ABBREVIATION KEY	INV-# LIGHTING INVERTER 26 52 00 MH-# MANHOLE 26 05 37	RECTANGLE SYMBOL. A. EXAMPLE CONTROL STATION: SYMBOL "#B", TAGGED "SW-#B", DESCRIPTION	"NL"	INDICATES L	JMINAIRE IS U	NSWITCHED FOR NIGHT LIGHT. WITCHED/CONTROLLED DURING NORMAL	
ABBR: DESCRIPTION:	MTS-# MANUAL TRANSFER SWITCH, REFER TO TRANSFER SWITCH SCHEDULE 26 36 00	"LIGHTING CONTROL STATION". B. EXAMPLE PANEL/RACK/CABINET: TAGGED "LCPR#", DESCRIPTION "ROOM BASED				ROM EMERGENCY CIRCUIT UPON LOSS OF POWER.	
ABV ABOVE	R-# RELAY 26 09 39 SB-# SWITCHBOARD 26 24 13	LIGHTING CONTROL PANEL/RACK/CABINET. C. EXAMPLE CONTROL DESIGNATIONS: a, b, c			NTED HORIZO (: F1 / 1 / a / NL	NTALLY A SLASH WILL SEPARATE THIS	
AFC ABOVE FINISHED CEILING	SPD-# SURGE PROTECTION DEVICE 26 43 00	 D. LIGHTING CONTROL STATION "#B" a,b CONTROLS LUMINAIRES WITH THE SUBSCRIPT "a" AND "b" WITHIN THE SAME SPACE E. REFER TO THE LIGHT CONTROL SEQUENCE OF OPERATION TAG {L#-##} FOR A 					
AFF ABOVE FINISHED FLOOR	UPS-#UNINTERRUPTIBLE POWER SUPPLY26 33 53VFD-#VARIABLE FREQUENCY DRIVE - REFER TO VFD SCHEDULE26 29 23	COMPLETE DESCRIPTION OF THE LIGHTING CONTROL AND PRE-PROGRAMMED SCENE SELECTION REQUIREMENTS.					
AFG ABOVE FINISHED GRADE ASR ARCHITECTURAL SURFACE RACEWAY		F# F# a,b					
BC BELOW COUNTER	RECEPTACLE SUBSCRIPT KEY:	LUMINAIRE LUMINAIRE CONTROL					
C CONDUIT (BRANCH CIRCUIT OR FEEDER CONTEXT) CO CONDUIT AND BOX ROUGH-IN ONLY (ROUGH-IN ONLY)							
EG EQUIPMENT GROUND	DEVICE	LIGHTING CONTROL NOTES:					
EGC EQUIPMENT GROUNDING CONDUCTOR	*IF LABEL IS ORIENTED HORIZONTALLY A SLASH WILL SEPARATE THIS INFORMATION. EX: A / 1	LIGHTING CONTROL NOTES:					
EPO EMERGENCY POWER OFF NEMA # NEMA RATING	ELECTRICAL MOUNTING SUBSCRIPT KEY:	{L#-##} INDICATES THE LIGHTING SEQUENCE OF OPERATION FOR THE SPACE. REFER TO THE					
NEMA # NEMA RATING NIC NOT IN CONTRACTED SCOPE	A MOUNT AT +6" TO CENTERLINE ABOVE COUNTER OR BACKSPLASH C MOUNT AT CEILING (DEVICE OR ROUGH-IN CONTEXT) H MOUNT ORIENTED HORIZONTALLY	LIGHTING SEQUENCE OF OPERATION MATRIX ON SHEET E/600. {#B} LIGHTING CONTROL STATION. THE "#" INDICATES THE MINIMUM QUANTITY OF					
ROOF EQUIPMENT LOCATED ON ROOF ABOVE	H MOUNT ORIENTED HORIZONTALLY L MOUNT IN CASEWORK M MOUNT IN MODULAR FURNITURE	ZONES/SCENES AS DEFINED IN THE LIGHTING SEQUENCE OF OPERATIONS. THE LIGHTING CONTROL STATION SHALL PROVIDE SEPARATE ON AND OFF AS WELL AS RAISE AND LOWER					
SM SURFACE MOUNTED TYP TYPICAL	O WIRING DEVICE, OCCUPANCY CONTROLLED R MOUNT IN SURFACE RACEWAY	BUTTON(S). CONTROL SHALL BE CAPABLE OF DIMMING UP/DOWN AND SWITCHING AS DEFINED IN THE LIGHTING SEQUENCE OF OPERATIONS. REFER TO DRAWINGS AND LUMINAIRE					
UG UNDERGROUND	S SURFACE MOUNTED W WEATHERPROOF WIRING DEVICE, NEMA 3R WHILE-IN-USE COVER, WR LISTED	SUBSCRIPTS TO DETERMINE IF A ROOM BASED CONTROLLER (a, b, c SUBSCRIPTS).					
UON UNLESS OTHERWISE NOTED	WG WIRE GUARD WP WEATHERPROOF	{z##} INDICATES ZONING AND REFLECTS A LIGHTING CONTROL GROUP. PROVIDE RELAYS AS REQUIRED TO ALLOW LUMINAIRES WITHIN THE DEFINED ZONE TO FUNCTION TOGETHER.					
		LIGHTING CONTROL SUBSCRIPTS: 1. LOWER CASE ALPHA SUBSCRIPTS "a, b, c" INDICATE LINE VOLTAGE OR ROOM BASED					
		LIGHTING CONTROL SYSTEMS. REFER TO DRAWINGS TO DETERMINE IF LINE VOLTAGE CONTROL (S, S3, S4, ETC) OR {#B} ROOM BASED CONTROLLER SYSTEM (#B) IS REQUIRED.					
		EMERGENCY LIGHTING OVERRIDE CONTROL (UL924 AND UL1008): LIGHTING CONTROL EQUIPMENT COUPLED WITH REMOTE EMERGENCY POWER SOURCES (EXTERNAL TO THE LUMINAIRE) REQUIRE ALCR (UL924) OR BCELTS (UL1008) DEVICES FOR EMERGENCY (LIFE SAFETY) COMPLIANCE. AN EMERGENCY LIGHTING CONTROL BYPASS IS REQUIRED FOR EVERY					

SAFETY) COMPLIANCE. AN EMERGENCY LIGHTING CONTROL BYPASS IS REQUIRED FOR EVERY INDIVIDUAL LIGHTING CONTROL ZONE-CIRCUIT BUT NOT SHOWN ON THE PLANS. REFER TO THIS SPECIFICATION FOR ALCR AND BCELTS DESCRIPTIONS. REFER TO THE SEQUENCE OF OPERATION LIGHTING CONTROL DESCRIPTIONS ON THE PLANS FOR ADDITIONAL REQUIREMENTS.

REFER TO SHEET E600 FOR LUMINAIRE SCHEDULE

REFER TO SHEET E400 FOR LIGHTING CONTROL ONE-LINE DIAGRAM											
25	24	23	22	21	20	19	18	17	16	15	14



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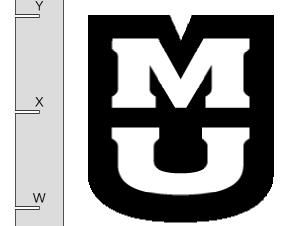
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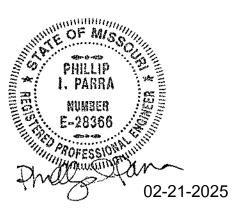
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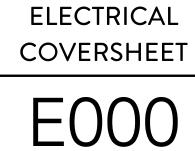
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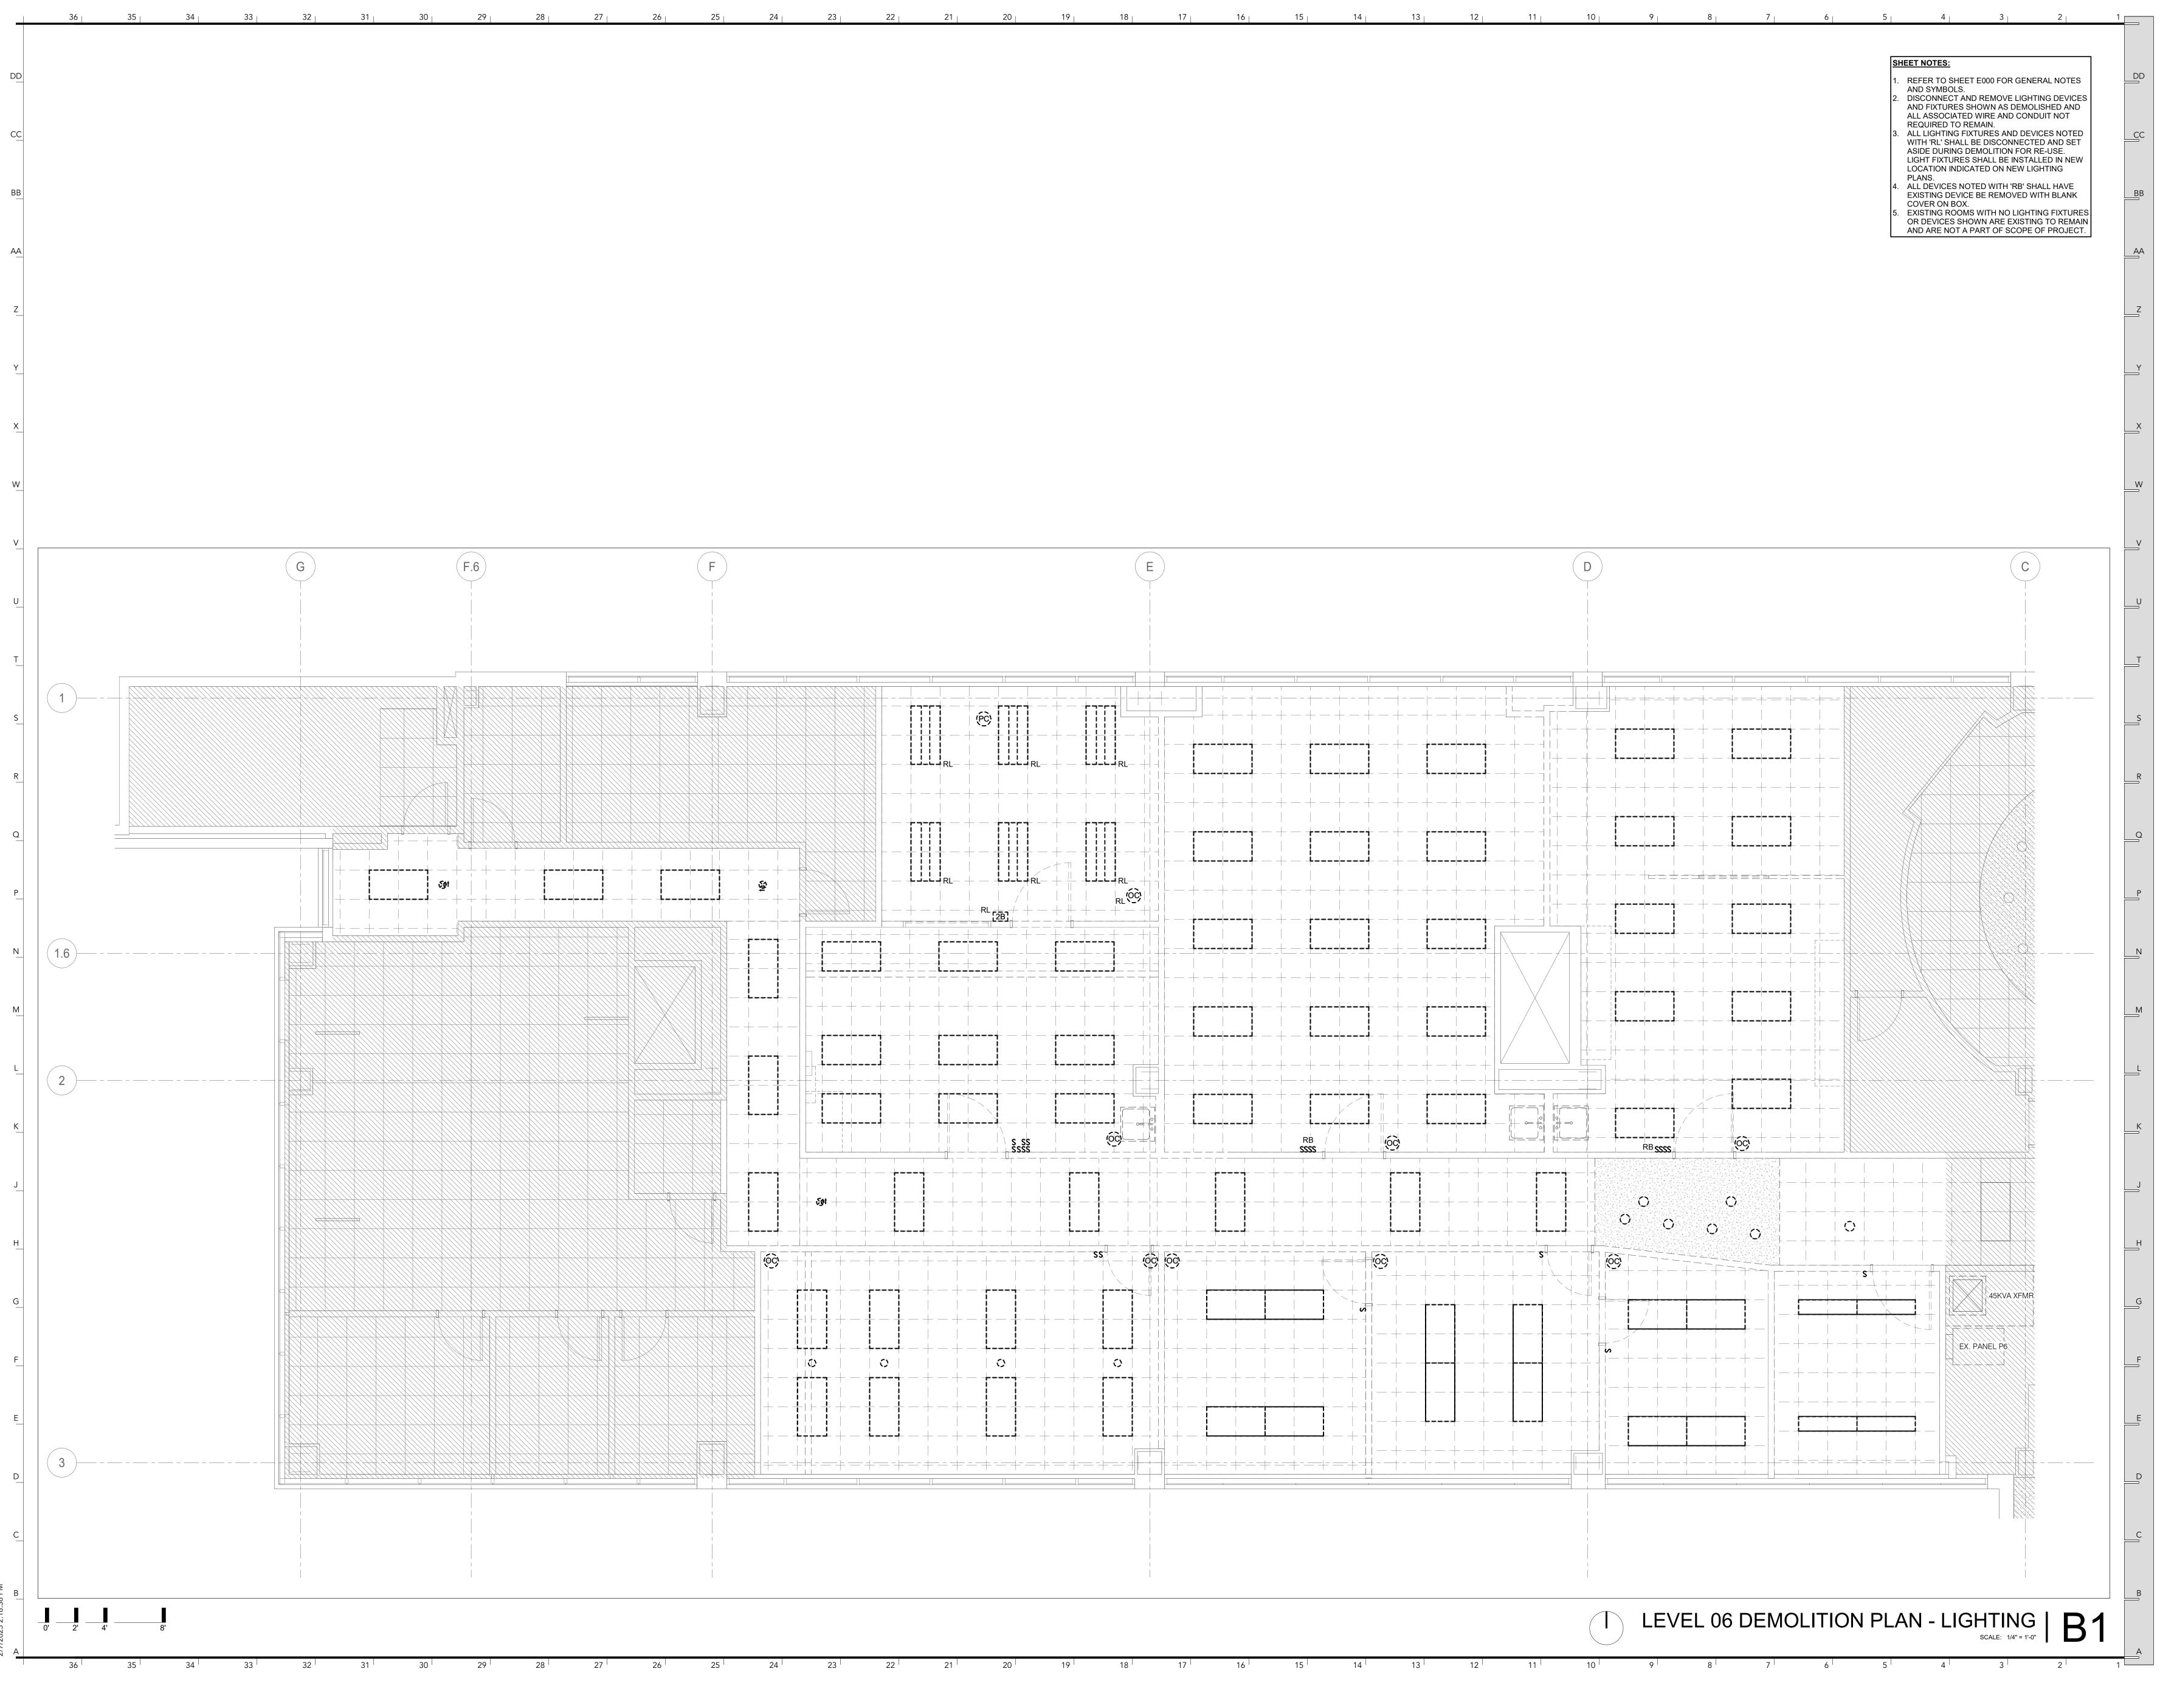
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LEVEL 06

DEMOLITION PLAN -

E106

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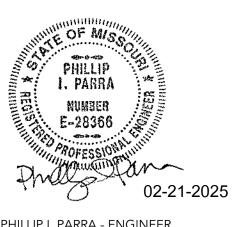
CLINICAL SUPPORT & EDUCATION SIM CENTER TRAINING SPACE RENOVATION PHASE II

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DATE: PROJ. NO.:	02/21/2025 CP250271
DESIGNED BY:	ZMB
DRAWN BY:	ZMB
CHECKED BY:	PLR
APPROVED BY:	PLR


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FOR THE CURATORS OF THE UNIVERSITY OF MISSOURI




ISSUED FOR BID

5 HOSPITAL DR. COLUMBIA, MO 65201

DATE: PROJ. NO.:	02/21/2025 CP250271
DESIGNED BY:	ZMB
DRAWN BY:	ZMB
CHECKED BY:	PLR
APPROVED BY:	PLR

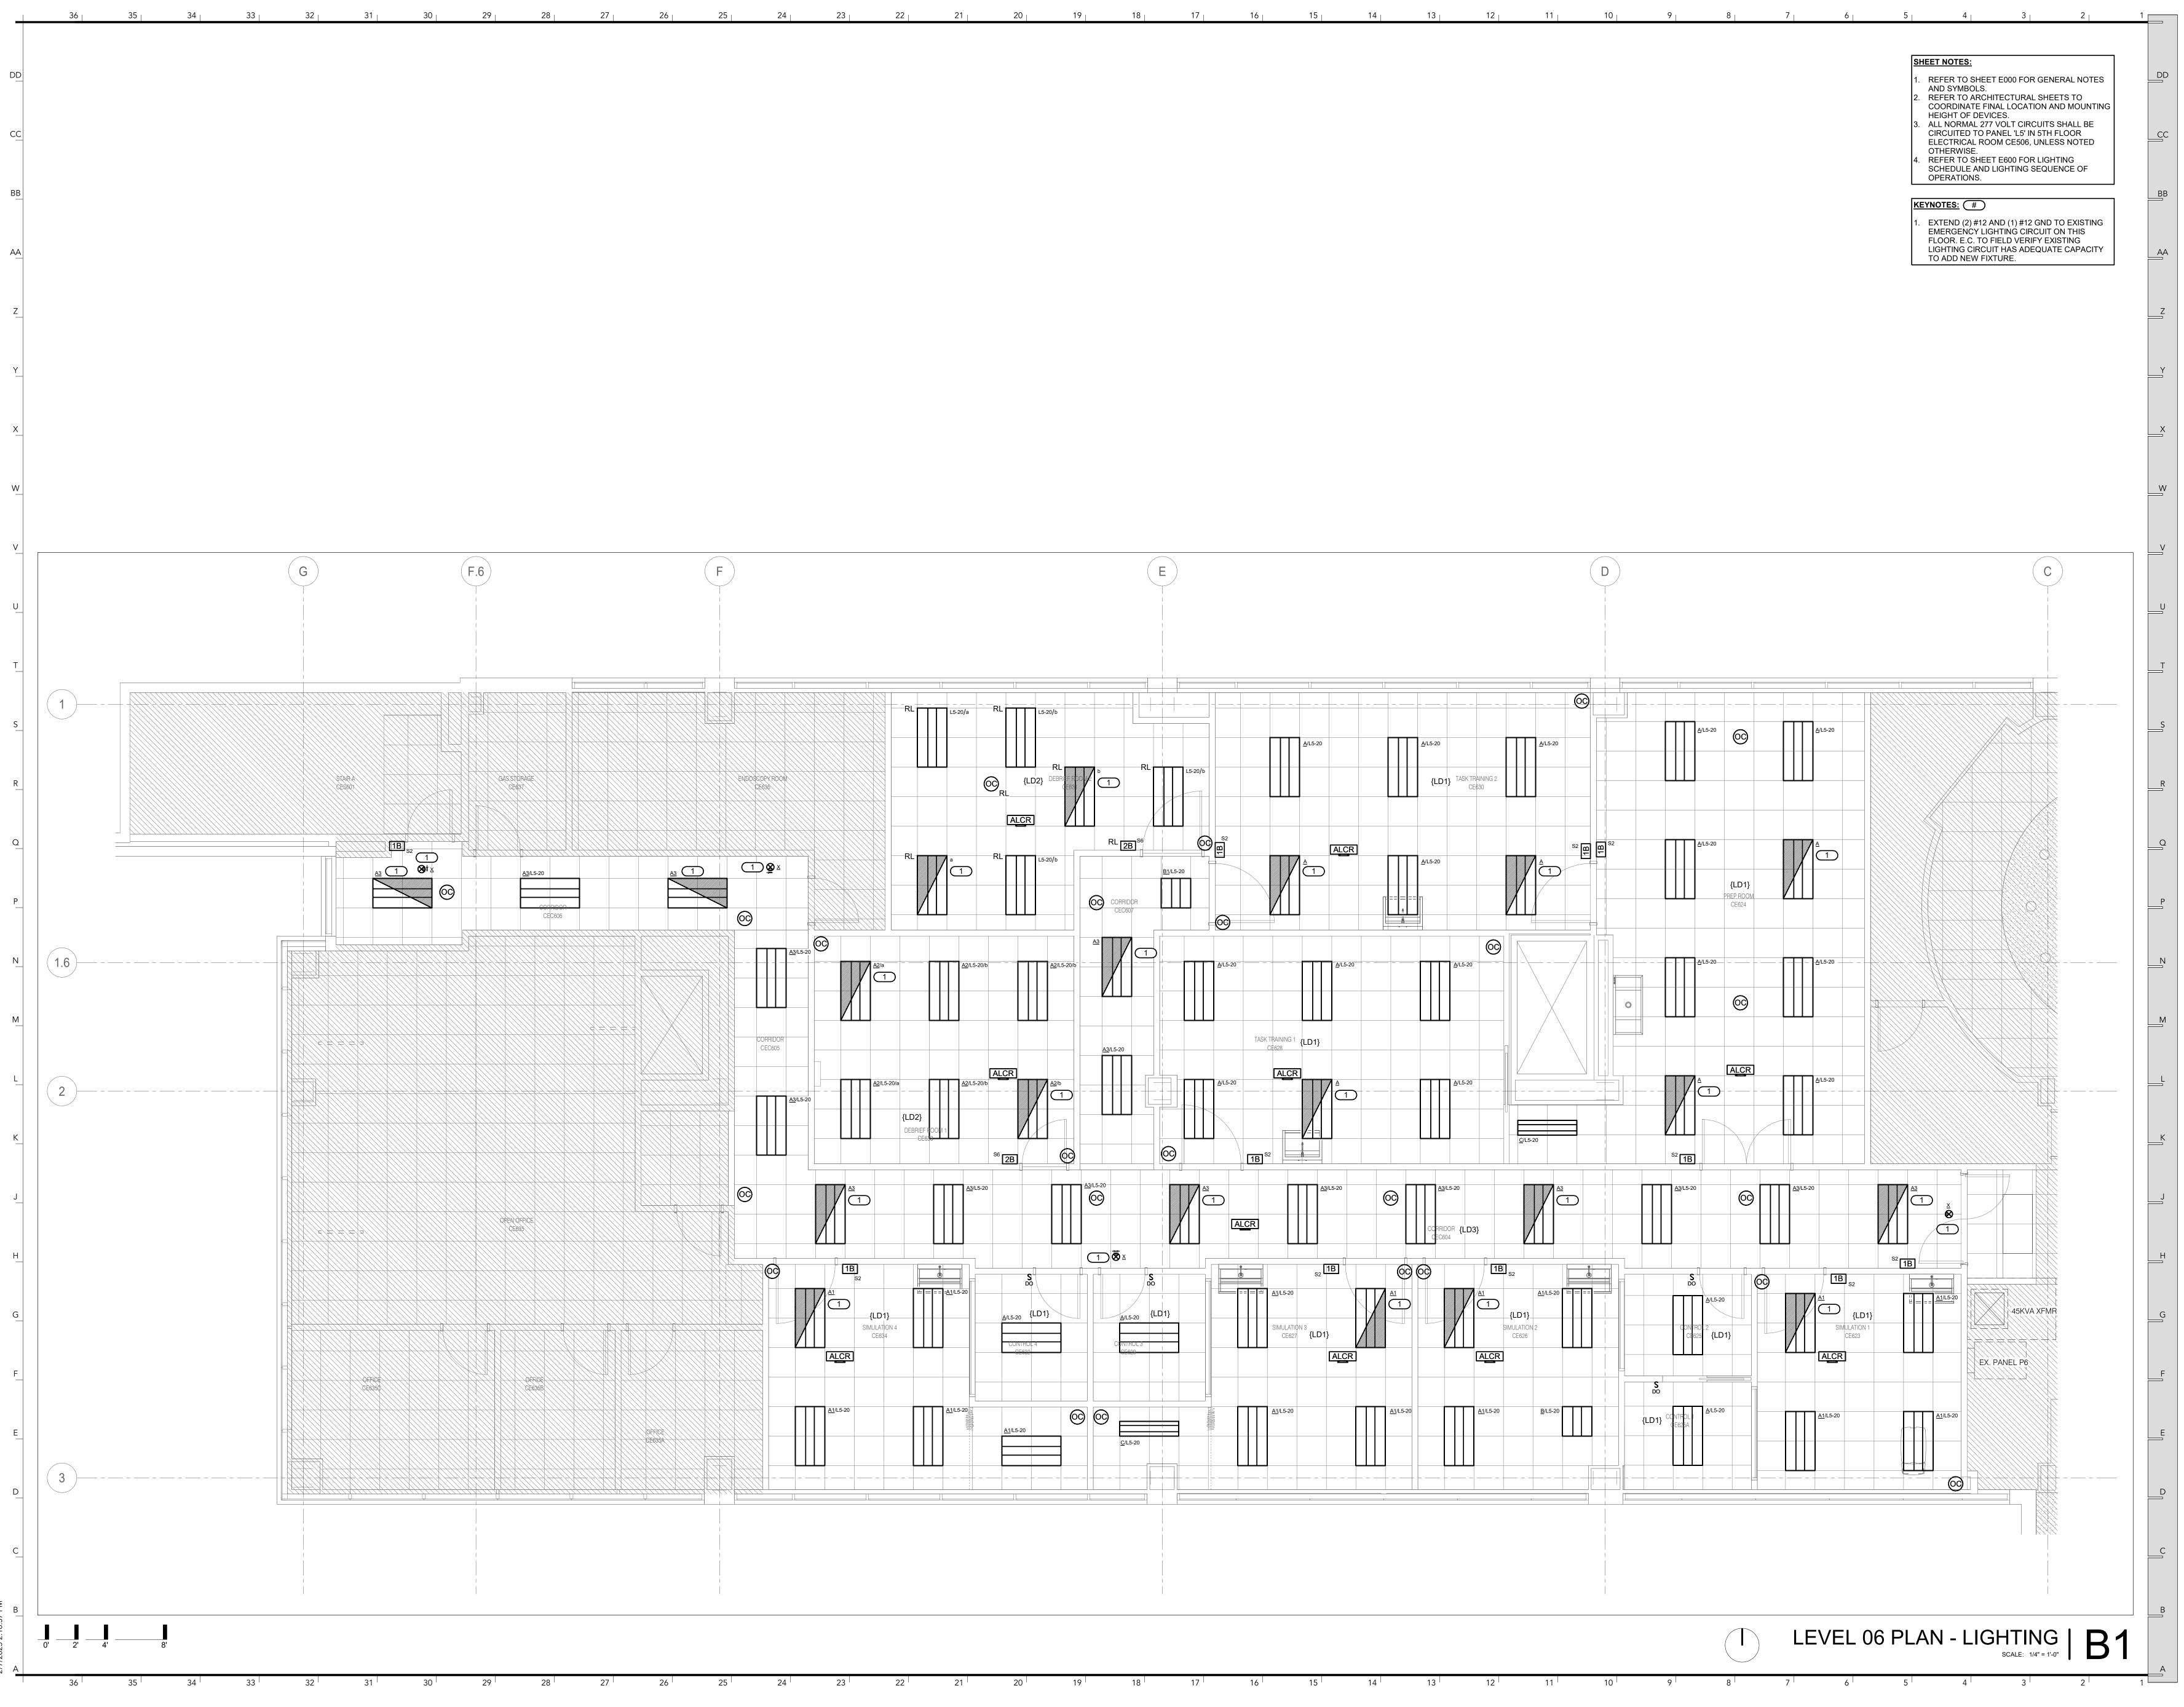SEAL:

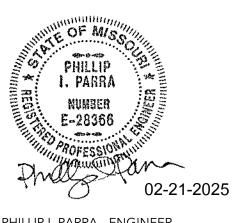

PHILLIP I. PARRA - ENGINEER MO#: E-28366

The Professional Engineer's seal affixed to this sheet applies only to the material and items shown on this sheet. All drawings, instruments, or other documents not exhibiting this seal shall not be considered prepared by this engineer, and this engineer expressly disclaims any and all responsibility for such plans, drawings, or documents not exhibiting this seal.

NO.	REVISION SUBMISSION	DATE
0	ISSUED FOR BID	02/21/2025







MEP CONSULTANT

1600 BALTIMORE, SUITE 300 KANSAS CITY, MO 64108

STRUCTURAL CONSULTANT

COLUMBIA, MO 65203

FOR THE CURATORS OF

THE UNIVERSITY OF MISSOURI

CLINICAL

SUPPORT &

EDUCATION

SIM CENTER

RENOVATION

TRAINING

SPACE

PHASE II

5 HOSPITAL DR.

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ZMB

PLR

PLR

02-21-2025

ISSUED FOR BID

PH: 573.447.0292

CROCKETT ENGINEERING CONSULTANTS

1000 W. NIFONG BOULEVARD, BUILDING 1


IMEG CORP.

PH: 816.842.8437

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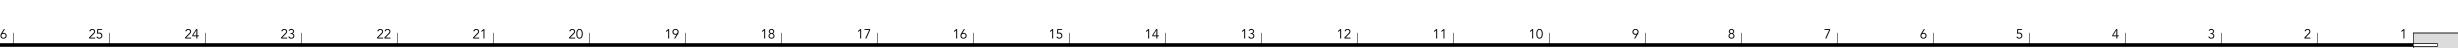
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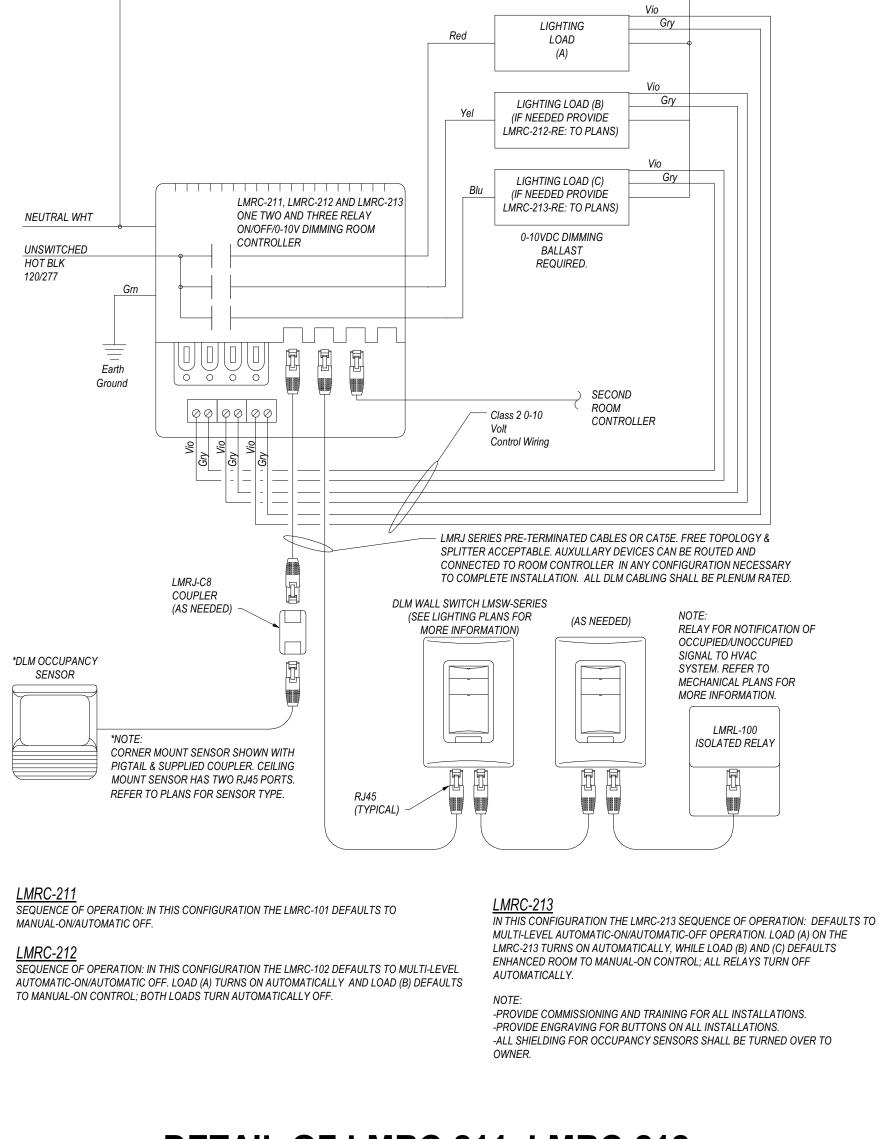
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PHILLIP I. PARRA - ENGINEER MO#: E-28366

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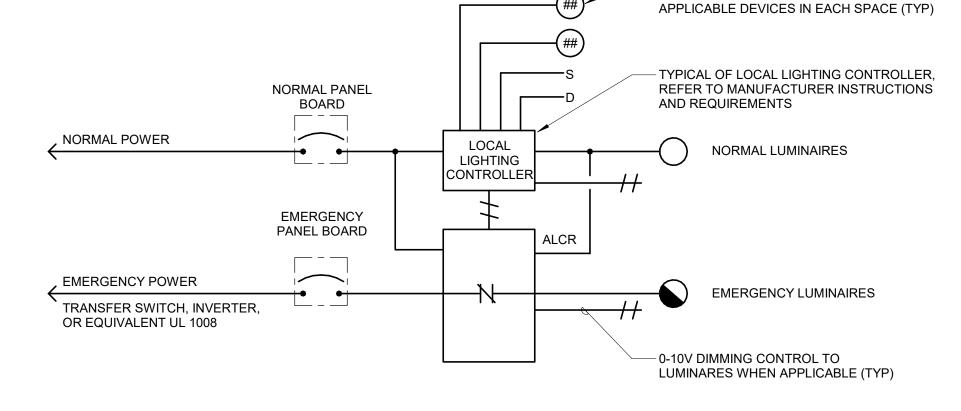
DETAIL OF LMRC-211, LMRC-212 AND LMRC-213 ROOM 1 CONTROLLER CABLING

18

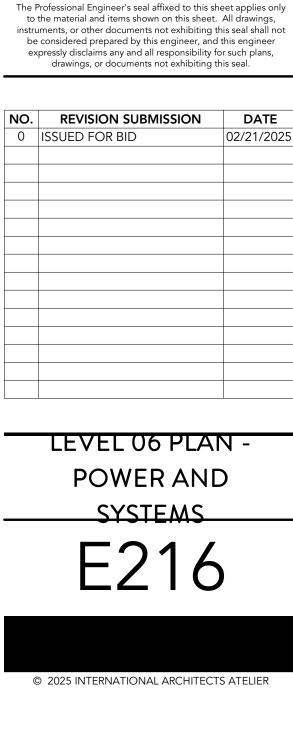-LIGHTING SENSORS, SWITCHES, AND DIMMERS. REFER TO PLANS FOR

AUTOMATIC LOAD CONTROL 3 RELAY DIAGRAM (ALCR) NO SCALE E_LCO8

- 4. FIRE ALARM ADDRESSABLE RELAY SHALL OVERRIDE LOCAL LIGHTING CONTROLS UPON FIRE ALARM OR TEST.
- OF CORRIDOR AND ADJACENT TO FIRST SENSOR OR CONTROL DEVICE. 3. MOUNT ALCR ADJACENT TO LIGHTING CONTROLLER ABOVE ACCESSIBLE FINISHED CEILING.
- DEVICES, WIRING, AND CONNECTIONS REQUIRED. REFER TO MANUFACTURER'S INSTALLATION INSTRUCTIONS AND REQUIREMENTS. 2. MOUNT LOCAL LIGHTING CONTROLLERS ABOVE FINISHED CEILING NEAR ROOM ENTRANCE. IN A CORRIDOR, MOUNT NEAR ONE END
- 1. THE ALCR RELAY DIAGRAM IS INTENDED TO CONVEY INTENDED OPERATION AND SPECIFICALLY DOES NOT INDICATE QUANTITIES, ALL
- NOTES:



2 HOSPITAL CARD READER DETAIL NO SCALE


1. DETAIL IS DIAGRAMMATIC ONLY AND MAY NOT REPRESENT ACTUAL DEVICES/QUANTITY OF DEVICES REQUIRED. COORDINATE ALL REQUIREMENTS WITH FINAL DOOR HARDWARE PROVIDED

KEYED NOTES:

2. STUB CONDUIT 6" ABOVE ACCESSIBLE CEILING.

IN LOCAL TELECOMMUNICATION ROOM.

CEILING SPACE

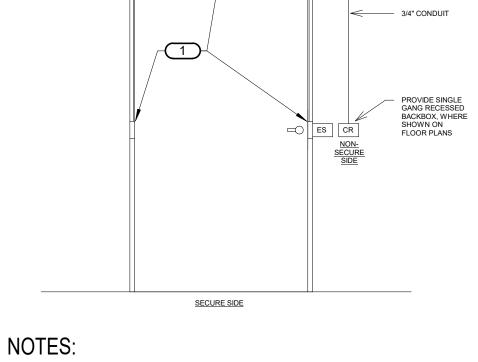

AND AS CALLED OUT ON ARCHITECTURAL DRAWINGS. COORDINATE WITH SECURITY SYSTEM

2. COORDINATE FINAL REQUIREMENTS WITH ACCESS CONTROL VENDOR. PROVIDE EACH ACCESS

CONTROL DOOR WITH ONE (1) 18/6 UNSHIELDED CABLE AND ONE (1) 22/6 SHIELDED CABLE.

1. PROVIDE JUNCTION BOXES FLUSH WITHIN THE DOOR FRAME WITH 1/2" FLEXIBLE CONDUIT

BETWEEN BOXES AS REQUIRED FOR ROUTING OF ACCESS CONTROL WIRING INSIDE DOOR

3. LOW VOLTAGE ACCESS CONTROL SYSTEM CABLES: ROUTE TO DOOR ACCESS CONTROL PANEL

INSTALLER FOR EXACT ROUGH-IN LOCATIONS AND REQUIREMENTS.

 $3 \\ 2$


1/2" CONDUIT

 $\begin{array}{c}3\\2\\2\end{array}$








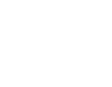



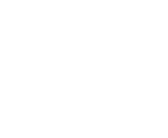









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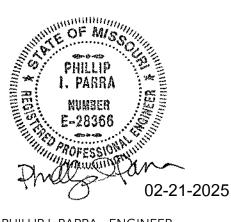


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0	ISSUED FOR BID	02/21/2025

ELECTRICAL DETAILS

E400

1

2

	EX. PANEL P6	
MOUNTING: SURFACE ENCLOSURE: NEMA 1 FED FROM: 0/0P @	SINGLE TUB SOLID NEUTRAL GROUND BUS	MAIN: 150 MCB VOLTS: 120/208 Wye PHASE: 3
LOCATION: ELEC. CE619		WIRE: 4 SCCR: 65 kA ISC UNKNOWN 0.00 kA
NOTES:		
	OCPD SIZE A B C SIZ	ZE OCPD CKT
YNO.LOAD DESCRIPTION1EXISTING LOAD3EXISTING LOAD5EXISTING LOAD		I P AMPS LOAD DESCRIPTION NO. - 1 20 EXISTING LOAD 2 - 1 20 EXISTING LOAD 4 - 1 20 EXISTING LOAD 6
7EXISTING LOAD9EXISTING LOAD11EXISTING LOAD	20 1 0 0	1 20 EXISTING LOAD 8 - 1 20 EXISTING LOAD 10 - 1 20 EXISTING LOAD 10 - 1 20 EXISTING LOAD 12
13EXISTING LOAD15EXISTING LOAD17EXISTING LOAD19EXISTING LOAD	20 1 0 0	- 1 20 EXISTING LOAD 14 - - 1 20 EXISTING LOAD 16 - - 1 20 EXISTING LOAD 18 - 1 20 EXISTING LOAD 20 - 1 20 EXISTING LOAD 20
19 EXISTING LOAD 21 EXISTING LOAD 23 EXISTING LOAD 25 EXISTING LOAD	20 1 0 0	1 20 EXISTING LOAD 22 1 20 EXISTING LOAD 24
27EXISTING LOAD29EXISTING LOAD31EXISTING LOAD	20 1 0 0	1 20 EXISTING LOAD 28 1 20 EXISTING LOAD 30 1 20 EXISTING LOAD 32
33 EXISTING LOAD 35 EXISTING LOAD 37 EXISTING LOAD 39 EXISTING LOAD	20 1 0 0 20 1 0 0 0 20 1 0 0 20 1 0 0 20 1 0 0 20 1 0 0	- 1 20 EXISTING LOAD 36 - 1 20 EXISTING LOAD 38
39EXISTING LOAD41EXISTING LOAD43EXISTING LOAD45EXISTING LOAD	20 1 0 0	1 20 EXISTING LOAD 42
47EXISTING LOAD49EXISTING LOAD51EXISTING LOAD	20 1 0 0 20 1 0 0 </td <td> 1 20 EXISTING LOAD 48 - 1 20 EXISTING LOAD 50 - 1 20 EXISTING LOAD 50 - 1 20 EXISTING LOAD 52</td>	1 20 EXISTING LOAD 48 - 1 20 EXISTING LOAD 50 - 1 20 EXISTING LOAD 50 - 1 20 EXISTING LOAD 52
53EXISTING LOAD55EXISTING LOAD57EXISTING LOAD		1 20 EXISTING LOAD 54 - 1 20 EXISTING LOAD 56 - 1 20 EXISTING LOAD 58
59EXISTING LOAD61EXISTING LOAD63EX. VAV POWER SUPPLY BOX65EXISTING LOAD	20 1 0 0.9 12 1	- 1 20 EXISTING LOAD 60 2 12 1 20 REC: DEBRIEF RM 2 & ENDOSCOPY RM 62 2 12 1 20 REC: PREP RM 64 2 12 1 20 REC: PREP RM 64 2 12 1 20 REC: PREP RM 66
B 67 REC: SIM 1 B 69 REC: RMS SIM 1, CONTROL 1&2 B 71 REC: RMS SIM 2, CONTROL 1&2	20 1 12 12 1.26 1.26	2 12 1 20 REC: TASK TRAINING 2 68 2 12 1 20 REC: TASK TRAINING 2 70 2 12 1 20 REC: TASK TRAINING 2 70 2 12 1 20 REC: TASK TRAINING 1 72
B 73 REC: SIM 2 B 75 REC: SIM 3 B 77 REC: SIM 3 & CONTROL 3 B 79 REC: SIM 4 & CONTROL 4	20 1 12 12 12 1.46 1.26 12 12 1 20 1 12 12 12 1 1 1 12 1	2 12 1 20 REC: TASK TRAINING 1 74 2 12 1 20 REC: DEBRIEF 2 76 2 12 1 20 REC: DEBRIEF 1 78 2 12 1 20 HEAD WALL: SIM 182 80
B79REC: SIM 4 & CONTROL 4B81REC: SIM 4B83DOOR HARDWARE: MAIN CORR. & P	20 1 12 12 12 1 1.46 1 12 12 1	2 12 1 20 HEAD WALL: SIM 1&2 80 2 12 1 20 HEAD WALL: SIM 3&4 82 2 12 1 20 DOOR HARDWARE: TASK TRAINING 1&2 84
	Total Amps: 66.91 73.41 66.33 LOAD SUMMARY	
LOAD CLASSIFICATION Power	CONNECTED LOAD DEMAND FACTOR ESTIMATED DEMAND 4.8 kVA 100.00% 4.8 kVA	TOTALS*
Receptacles	19.98 kVA 75.03% 14.99 kVA	TOTAL CONNECTED LOAD: 24.78 kVA TOTAL ESTIMATED DEMAND LOAD: 40.70 kVA
*TOTAL DEMAND CALCS SUBT CIRCUIT KEY NOTES: A - EXISTING S	ACT ANY REDUNDANT LOAD AND THE SMALLER OF ANY NONCOINCIDE PARE CIRCUIT BREAKER. B - FURNISH AND INSTALL CIRCUIT BREAKER (KER HAS EXISTING LOAD + NEW ADDED LOAD.	TOTAL ESTIMATED DEMAND LOAD:19.79 kVATOTAL CONNECTED AMPS:68.78 ATOTAL ESTIMATED DEMAND AMPS:54.9T HVAC LOADS. THIS CALC IS DONE AT EACH PANEL.
*TOTAL DEMAND CALCS SUBT CIRCUIT KEY NOTES: A - EXISTING S	ACT ANY REDUNDANT LOAD AND THE SMALLER OF ANY NONCOINCIDE PARE CIRCUIT BREAKER. B - FURNISH AND INSTALL CIRCUIT BREAKER (TOTAL ESTIMATED DEMAND LOAD:19.79 kVATOTAL CONNECTED AMPS:68.78 ATOTAL ESTIMATED DEMAND AMPS:54.9T HVAC LOADS. THIS CALC IS DONE AT EACH PANEL.
*TOTAL DEMAND CALCS SUBT CIRCUIT KEY NOTES: A - EXISTING S - CIRCUIT BRE MOUNTING: SURFACE ENCLOSURE: NEMA 1 FED FROM: 0/0P @	ACT ANY REDUNDANT LOAD AND THE SMALLER OF ANY NONCOINCIDE PARE CIRCUIT BREAKER. B - FURNISH AND INSTALL CIRCUIT BREAKER (KER HAS EXISTING LOAD + NEW ADDED LOAD. EX. PANEL L5 SINGLE TUB SOLID NEUTRAL	TOTAL ESTIMATED DEMAND LOAD: 19.79 kVA TOTAL CONNECTED AMPS: 68.78 A TOTAL ESTIMATED DEMAND AMPS: 54.9 NT HVAC LOADS. THIS CALC IS DONE AT EACH PANEL. OF SIMILAR TYPE TO EXISTING BREAKERS IN THIS PANEL. C MAIN: 100 MLO VOLTS: 480/277 Wye PHASE: 3 WIRE: 4 SCCR: 65 kA
*TOTAL DEMAND CALCS SUBT CIRCUIT KEY NOTES: A - EXISTING S - CIRCUIT BRE - CIRCUIT BRE ENCLOSURE: NEMA 1 FED FROM: 0/0P @ LOCATION:	ACT ANY REDUNDANT LOAD AND THE SMALLER OF ANY NONCOINCIDE PARE CIRCUIT BREAKER. B - FURNISH AND INSTALL CIRCUIT BREAKER O KER HAS EXISTING LOAD + NEW ADDED LOAD. EX. PANEL L5 SINGLE TUB SOLID NEUTRAL GROUND BUS VIRE A B C VI	TOTAL ESTIMATED DEMAND LOAD: 19.79 kVA TOTAL CONNECTED AMPS: 68.78 A TOTAL ESTIMATED DEMAND AMPS: 54.9 NT HVAC LOADS. THIS CALC IS DONE AT EACH PANEL. OF SIMILAR TYPE TO EXISTING BREAKERS IN THIS PANEL. C MAIN: 100 MLO VOLTS: 480/277 Wye PHASE: 3 WIRE: 4 SCCR: 65 kA ISC UNKNOWN 0.00 kA
*TOTAL DEMAND CALCS SUBT CIRCUIT KEY NOTES: A - EXISTING S - CIRCUIT BRE - CIRCUIT BRE NOTES: K K CKT Y NOTES: LOCATION: VOTES: K CKT Y NOTES: LOCATION:	ACT ANY REDUNDANT LOAD AND THE SMALLER OF ANY NONCOINCIDEN PARE CIRCUIT BREAKER. B - FURNISH AND INSTALL CIRCUIT BREAKER OF KER HAS EXISTING LOAD + NEW ADDED LOAD. EX. PANEL L5 SINGLE TUB SOLID NEUTRAL GROUND BUS VIRE AMPS P H N G A B C VI SIZE A B C VI SIGE SIZE A B C VI SIGE SIZE A B C SI SIGE SIZE A B C SI SIZE A B C SI SI SIZE A B C SI SI SI SI SI SI SI SI SI SI	TOTAL ESTIMATED DEMAND LOAD: 19.79 kVA TOTAL CONNECTED AMPS: 68.78 A TOTAL ESTIMATED DEMAND AMPS: 54.9 NT HVAC LOADS. THIS CALC IS DONE AT EACH PANEL. OF SIMILAR TYPE TO EXISTING BREAKERS IN THIS PANEL. C WAIN: 100 MLO VOLTS: 480/277 Wye PHASE: 3 WIRE: 4 SCCR: 65 kA ISC UNKNOWN 0.00 kA CKT NO. 1 20 EXISTING LOAD 2 1 20 EXISTING LOAD 4
*TOTAL DEMAND CALCS SUBT CIRCUIT KEY NOTES: A - EXISTING S - CIRCUIT BRE - CIRCUIT BRE ENCLOSURE: NEMA 1 FED FROM: 0/0P @ LOCATION: NOTES: K CKT Y NO. LOAD DESCRIPTION 1 EXISTING LOAD	ACT ANY REDUNDANT LOAD AND THE SMALLER OF ANY NONCOINCIDED PARE CIRCUIT BREAKER. B - FURNISH AND INSTALL CIRCUIT BREAKER (KER HAS EXISTING LOAD + NEW ADDED LOAD.	TOTAL ESTIMATED DEMAND LOAD: 19.79 kVA TOTAL CONNECTED AMPS: 68.78 A TOTAL ESTIMATED DEMAND AMPS: 54.9 NT HVAC LOADS. THIS CALC IS DONE AT EACH PANEL. OF SIMILAR TYPE TO EXISTING BREAKERS IN THIS PANEL. C WOLTS: 480/277 Wye PHASE: 3 WIRE: 4 SCCR: 65 kA ISC UNKNOWN 0.00 kA CKT NO. - 1 20 EXISTING LOAD 2 - 1 20 EXISTING LOAD
*TOTAL DEMAND CALCS SUBT CIRCUIT KEY NOTES: A - EXISTING S - CIRCUIT BRE • I • ENCLOSURE: NEMA 1 • FED FROM: 0/0P @ • LOCATION: • I • CKT • Y • NOTES: • I • I EXISTING LOAD • 1 EXISTING LOAD • 1 EXISTING LOAD • 1 EXISTING LOAD • 1 EXISTING LOAD • 15 EXISTING LOAD • 15 EXISTING LOAD • 15 EXISTING LOAD • 15 EXISTING LOAD • 19 SPACE	ACT ANY REDUNDANT LOAD AND THE SMALLER OF ANY NONCOINCIDER ARE CIRCUIT BREAKER. B - FURNISH AND INSTALL CIRCUIT BREAKER O KER HAS EXISTING LOAD + NEW ADDED LOAD. EX. PANEL L5 SINGLE TUB SOLID NEUTRAL GROUND BUS VIRE 20 1 0 0 0 20 1 0 0 0	TOTAL ESTIMATED DEMAND LOAD: 19.79 kVA TOTAL CONNECTED AMPS: 68.78 A TOTAL ESTIMATED DEMAND AMPS: 54.9 THVAC LOADS. THIS CALC IS DONE AT EACH PANEL. DF SIMILAR TYPE TO EXISTING BREAKERS IN THIS PANEL. C MAIN: 100 MLO VOLTS: 480/277 Wye PHASE: 3 WIRE: 4 SCCR: 65 kA ISC UNKNOWN 0.00 kA KE CCPD CKT K CKT I 20 EXISTING LOAD 2
*TOTAL DEMAND CALCS SUBT CIRCUIT KEY NOTES: A - EXISTING S - CIRCUIT BRE - DISTING LOAD - TI - SEXISTING LOAD - TI - TI - TI - SUSTING LOAD - TI - TI	ACT ANY REDUNDANT LOAD AND THE SMALLER OF ANY NONCOINCIDER PARE CIRCUIT BREAKER. B - FURNISH AND INSTALL CIRCUIT BREAKER OF KER HAS EXISTING LOAD + NEW ADDED LOAD.	TOTAL ESTIMATED DEMAND LOAD: 19.79 kVA TOTAL CONNECTED AMPS: 68.78 A TOTAL ESTIMATED DEMAND AMPS: 54.9 IT HVAC LOADS. THIS CALC IS DONE AT EACH PANEL. OF SIMILAR TYPE TO EXISTING BREAKERS IN THIS PANEL. C MAIN: 100 MLO VOLTS: 480/277 Wye PHASE: 3 WIRE: 4 SCCR: 65 kA ISC UNKNOWN 0.00 kA CKT KKT VOLD EXISTING LOAD 2 - 1 20 EXISTING LOAD 2 - 1 20 EXISTING LOAD 2 - 1 20 EXISTING LOAD 1 - 1 20

12

12 12 11 10 0		_					
	8	7	6	5	4	3	2

DR:	DISTRIBUTION:	BEAMWIDTH:	(L/L) LENS/LOUVER:	K19 - KSH19 .156" ACRYLIC
FLAT ALUMINUM	II - ANSI/IES TYPE 2 DISTRIBUTION	NSP - VERY NARROW SPOT	A125" ACRYLIC	M - MATTE DIFFUSE CLEAR
FLAT STEEL	III - ANSI/IES TYPE 3 DISTRIBUTION	SP - SPOT	B - BAFFLE/LOUVER	N - NONE
REGRESSED ALUMINUM	IV - ANSI/IES TYPE 4 DISTRIBUTION	MD - MEDIUM	C - CLEAR ALZAK	P - POLYCARBONATE
REGRESSED STEEL	V - ANSI/IES TYPE 5 DISTRIBUTION	WD - WIDE	F - FROSTED ACRYLIC	R - HIGH IMPACT DR ACRYLIC
SH:		VWD - VERY WIDE	G - TEMPERED GLASS	SS - SEMI-SPECULAR CLEAR
- PAINT AFTER FABRICATION		WW - WALL WASH	K - KSH12 .125" ACRYLIC	O - OTHER (SEE DESCRIPTION)
A - COLOR-FINISH SELECTION	BY ARCHITECT			[DESIGN SPECIFIC BLANKS]
NTING:	RE - RECESSED		(WATT) PER: FIX - FIXTURE,	FT - FOOT, LAMP
CEILING SURFACE	SP - SUSPENDED		(TYPE) LED	RGB - COLOR CHANGING LED
COVE	SU - SURFACE		LED - LIGHT EMITTING DIODE	RGBW - COLOR CHANGING + WHITI
FLANGED RECESSED	UC - UNDER CABINET		TLED - TUBULAR LED LAMP	RGBA - COLOR CHANGING + AMBEI
PERIMETER	WL - WALL		OLED - ORGANIC LED	RLED - RETROFIT LED
POLE	O - OTHER (SEE DESCRIPTION)		DLED - DYNAMIC TUNABLE LED	WLED - WARM DIM LED
/ER:				
V - 0-10V DIMMING	EB - ELECTRONIC	HL - HIGH/LOW (100%/50%) STEP DIM	1	MV - MULTI-VOLTAGE ELECTRONIC
I - DIGITAL ADDRESSABLE	ELV - ELECTRONIC LOW VOLTAGE	LINE - LINE VOLTAGE DIMMING		REM - REMOTE
- DIGITAL MULTIPLEX	EM - EMERGENCY BATTERY	ML - MULTI-LEVEL SWITCHING		O - OTHER (SEE DESCRIPTION)

COORDINATE ALL CEILING TYPES WITH LUMINAIRE MOUNTING AND TRIM REQUIREMENTS PRIOR TO THE RELEASE OF THE LUMINAIRE ORDER. COLORS AND FINISHES OF ALL LUMINAIRE COMPONENTS WITH ARCHITECT AND INTERIOR DESIGNER PRIOR TO THE RELEASE OF THE LUMINAIRE ORDER. CATED ON LIGHTING PLANS OR BELOW, REFER TO ARCHITECTURAL AND INTERIOR DESIGN ELEVATIONS, SECTIONS AND DETAILS FOR ALL SUSPENDED AND WALL MOUNTED LUMINAIRE

ECIFICATION SECTIONS LED LIGHTING 26 51 19 FOR ADDITIONAL INFORMATION AND REQUIREMENTS. DRRELATED COLOR TEMPERATURE 3500K, COLOR RENDERING INDEX (CRI) AT OR ABOVE 80, UNLESS NOTED OTHERWISE.

10 [|]

9

8

7 '

6

5 '

4

3 '

11

		L MTG	DIMENSIONS			WATT LE			ED D	DRIVE	R			
DESCRIPTION	L/L		L	w	н	DIA.	ANSI WATTS	PER	TYPE	QTY	DELIVERED LUMENS (MIN)	VOLTS	TYPE	MANUFACTURER AND MODEL
' DIRECT/INDIRECT TROFFER FOR LED JRCE. DIFFUSE MATTE ACRYLIC CENTER ELDING. FIXTURE STEEL POST PAINTED ED WHITE ENAMEL.	0	RE	4'-0"	2'-0"	5 1/2"		39	FIX	LED		4500	277	0-10V	H.E. WILLIAMS AT1 SERIES
/E AS TYPE 'A' EXCEPT 4000 LUMEN IPUT.	0	RE	4'-0"	2'-0"	5 1/2"		34	FIX	LED	1	4000	277	0-10V	H.E. WILLIAMS AT1 SERIES
/E AS TYPE 'A' EXCEPT 3500 LUMEN IPUT.	0	RE	4'-0"	2'-0"	5 1/2"		30	FIX	LED	1	3500	277	0-10V	H.E. WILLIAMS AT1 SERIES
/E AS TYPE 'A' EXCEPT 2200 LUMEN IPUT.	0	RE	4'-0"	2'-0"	5 1/2"		19	FIX	LED	1	2200	277	0-10V	H.E. WILLIAMS AT1 SERIES
DIRECT/INDIRECT TROFFER FOR LED JRCE. DIFFUSE MATTE ACRYLIC CENTER ELDING. FIXTURE STEEL POST PAINTED ED WHITE ENAMEL.	0	RE	2'-0"	2'-0"	5 1/2"		37	FIX	LED	1	4000	277	0-10V	H.E. WILLIAMS AT1 SERIES
IE AS TYPE 'B' EXCEPT 2200 LUMEN 'PUT.	0	RE	2'-0"	2'-0"	5 1/2"		21	FIX	LED	1	2200	277	0-10V	H.E. WILLIAMS AT1 SERIES
' DIRECT/INDIRECT TROFFER FOR LED JRCE. DIFFUSE MATTE ACRYLIC CENTER ELDING. FIXTURE STEEL POST PAINTED (ED WHITE ENAMEL.	0	RE	4'-0"	1'-0"	5 1/2"		30	FIX	LED	1	3000	277	0-10V	H.E. WILLIAMS AT1 SERIES
GE-FACE OR DOUBLE-FACE EDGE LIT RYLIC LED EXIT SIGN. RED LETTERING. RNISH WITH NECESSARY MOUNTING RDWARE FOR CEILING AND CONFIGURE CES AND ARROWS AS SHOWN ON PLANS. RNISH WITH SELF BATTERY BACKUP WITH .F-DIAGOSTICS.	0	CL	1'-1"	2"	9"		3	FIX	LED	1	L.E.D.	277	EM	LITHONIA EDGR

LIGHTING SEQUENCE OF OPERAT	ION
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NOTES:	UTES:						
1. {L##} DENG 2. [#B] PUSH SWITCHING COORDINATI 3. [Z#] DENO ASSOCIATEE 4. a = SWITC 5. VERIFY AN 6. VERIFY AN ZONES PER 7. VERIFY AN	OTES THE LIGHTING SEQUENCE OF OPERATIONS FOR THIS SPACE. BUTTON REFERS TO SCENE QUANTITY. CONTROL STATION SHALL BE CAPABLE OF [RAISE/LOWER AND] ON/OFF FOR MULTIPLE SCENES AS INDICATED ON SHEETS AND THE LIGHTING SEQUENCE OF OPERATIONS {L##}. E QUANTITIES OF BUTTONS FOR CONTROL STATIONS WITH LIGHTING CONTROL MANUFACTURER. TES LIGHTING CONTROL ZONE. PROVIDE SEPARATE CONTROL OF EACH CONTROLLED ZONE. LUMINAIRES OWITH THE SAME ZONE SHALL OPERATE TOGETHER WITHIN THE SAME PROGRAMMED SCENE. H DESIGNATION FOR LIGHTING CONTROL ND COORDINATE ALL TIME CLOCK SETTINGS WITH OWNER PRIOR TO FINAL PROGRAMMING. ND COORDINATE ALL PUSH BUTTON WALL DEVICES AND QUANTITIES OF INDIVIDUAL BUTTONS WITH SCENES AND LOCATION. ND COORDINATE ALL PUSH BUTTON QUANTITIES AND SCENE NAMES WITH OWNER PRIOR TO SUBMITTING TEMPLATE TO MANUFACTURER.						
PLAN ID	LIGHTING SWITCHED						
{LD1}	 {LD1} Sequence: Dimmed lights are controlled in this space. ON: The lights shall turn on manually via lighting control station. ADJUST: The dimming luminaires are raised/lowered using a push button wall controller(s). OFF: The lights turn off manually via lighting control station, or automatically shut off, via occupancy sensor, once the space has been unoccupied for 20 minutes. Upon loss of normal power, all emergency luminaires shall turn ON via emergency lighting circuit. 						
{LD2}	Sequence: Multiple zones of lights are controlled in this space. ON: All light zones in this space shall turn on manually via 1 button on the wall control station. ADJUST: Each lighting zone shall be raised/lowered separately using a push button wall controller(s). OFF: All light zones in this space shall turn off together manually using 1 button on the wall control station, or automatically shut off, via occupancy sensor, once the space has been unoccupied for 20 minutes. Upon loss of normal power, all emergency luminaires shall turn ON via emergency lighting circuit.						
{LD3}	Sequence: Dimmed lights are controlled in this space. ON: The lights shall turn on automatically to 100% via occupancy sensor. OFF: The lights shall reduce output to 50% when unoccupied for 20 minutes, via occupancy sensor, or turn off manually via wall control switch. Upon loss of normal power, all emergency luminaires shall turn ON via emergency lighting circuit.						

POKE-THROUGH SCHEDULE										
TAG NAME	TYPE	CORE SIZE	POWER	DATA / AV	MANUFACTURER					
PT-1	POKE-THROUGH	8"	2 DUPLEX	C2 DATA JACK WITH 1-1/4" CONDUIT & 1-1/4" AV CONDUIT	HUBBELL SYSTEM ONE SERIES OR APPROVED EQUAL					
IOTES:										

1. PART NUMBERS REPRESENT MODEL FAMILY AND ARE NOT INCLUSIVE OF COVER AND DEVICE SPECIFICATIONS. ASSUME ALL PARAMETERS IN THE TABLE ABOVE.

2. PROVIDE ALL LINE AND LOW VOLTAGE CONDUIT SYSTEMS BACK TO THEIR RESPECTIVE SOURCE OF TERMINATION. REFER TO POWER AND SYSTEMS DRAWINGS.

3. ALL FINISH OPTIONS SHALL BE CONFIRMED BY ARCHITECT DURING THE CONSTRUCTION SUBMITTAL PROCESS, INCLUDING CARPET FLANGES AND SURFACE FLOOR APPLICATIONS.

IN EXISTING BUILDINGS, INCLUDE CHANNELING, PATCHING AND REPAIRING OF EXISTING SLABS. SCAN X-RAY/GPR AND SCHEDULE WORK ON OVERTIME BASIS AS NEEDED.



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STRUCTURAL CONSULTANT

CROCKETT ENGINEERING CONSULTANTS

1000 W. NIFONG BOULEVARD, BUILDING 1

KANSAS CITY, MO 64108

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FOR THE CURATORS OF THE UNIVERSITY OF MISSOURI

CLINICAL

SUPPORT &

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SIM CENTER

RENOVATION

TRAINING

SPACE

PHASE II

5 HOSPITAL DR.

DATE:

SEAL:

PROJ. NO.:

DESIGNED BY:

DRAWN BY: CHECKED BY:

APPROVED BY:

PHILLIP I. PARRA NUMBER E-28366 450 H 460

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PHILLIP I. PARRA - ENGINEER

MO#: E-28366

The Professional Engineer's seal affixed to this sheet applies only to the material and items shown on this sheet. All drawings, instruments, or other documents not exhibiting this seal shall not be considered prepared by this engineer, and this engineer expressly disclaims any and all responsibility for such plans, drawings, or documents not exhibiting this seal.

NO. REVISION SUBMISSION DATE

ELECTRICAL

SCHEDULES

E600

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